


PLOTTED BY:- KEN DATE:- 2 May 2025 3 34 PM FILENAME:- O:\PROJECTS\2023\23128 - 34 WYNDELLA ROAD, LOCHINVAR\CAD\TITLE\23128\_CIV\_DA-[E]\_34 WYNDELLA ROAD

# **CIVIL & STORMWATER WORKS for 34 WYNDELLA ROAD** LOCHIVAR NSW 2321 **Prepared by** WALLACE INFRASTRUCTURE DESIGN PTY LTD

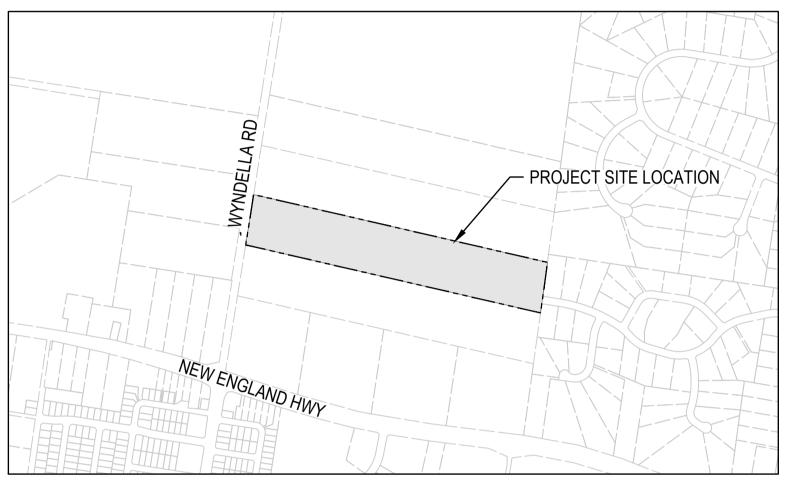

### **ABBREVIATIONS**

AGG ARCH ASP BM CAD C-C CH CI CJ CJ CL CO COG CONC CTRL CR CTS D DIA DP DRG D/S DTM EB EX ESL FH FFL FGL FSL FW GA GI GFL IC	ABOVE GROUND AGGREGATE ARCHITECT ASPHALT BENCHMARK COMPUTER AIDED DRAFTING CENTRE TO CENTRE CHAINAGE CAST IRON CONSTRUCTION JOINT COVER LEVEL or CENTRE LINE CLEAN OUT (SUBSOIL) CHANGE OF GRADE CONCRETE CONTROL CROWN CENTRES DEPTH DIAMETER DOWNPIPE DRAWING DOWN STREAM DIGITAL TERRAIN MODEL EDGE BITUMIN EXISTING EXISTING SURFACE LEVEL FIRE HYDRANT FIRE HOSE REEL FINISHED FLOOR LEVEL FINISHED GROUND LEVEL FINISHED GROUND LEVEL FINISHED GROUND LEVEL FINISHED GROUND LEVEL FINISHED SURFACE LEVEL FINISHED GROUND LEVEL FINISHED GROUND LEVEL FINISHED GROUND LEVEL FINISHED GROUND LEVEL FINISHED GROUND LEVEL FINISHED GROUND LEVEL FINISHED FLOOR LEVEL FINISHED GROUND LEVEL FINISHED GROUND LEVEL FINISHED GROUND LEVEL FINISHED FLOOR LEVEL FINISHED FLOOR LEVEL FINISHED FLOOR LEVEL FINISHED FINISHED LEVEL FINISHED FINISHED LEVEL INSPECTION CHAMBER INSIDE DIAMETER
AutoCAD Civil 3D 2021	

IFC IFCR IL IO KIP L PMAX MC MH MIN C MH MISC N NRV NTS OD OF OH PP PVC PV PVP QA QTY R RC REV RL RW SFW SI	ISSUED FOR CONSTRUCTION ISSUED FOR CLIENT REVIEW INVERT LEVEL INSPECTION OPENING KERB INLET PIT LENGTH LAMP POST (SURVEY) MAXIMUM MASS CONCRETE MANHOLE MINIMUM MISCELLANEOUS NORTH NON RETURN VALVE NOT TO SCALE OUTER DIAMETER OVERFLOW OVERFLOW OVERHEAD POWER POLE PERSONAL PROTECTIVE EQUIP. POLYVINYLCHLORIDE PRESSURE VENT PRESSURE VENT PR
RL	REDUCED LEVEL
RW	RETAINING WALL
SFW	SEALED FLOOR WASTE
SL	SURFACE LEVEL
SMH	SEWER MANHOLE
SMV	SEWER MAIN VENT
SOD	SIDE OUTLET DRAIN
S/S	STAINLESS STEEL
S/S STD	STAINLESS STEEL

SV	STOP VALVE
SW	STORMWATER
SWP	STORMWATER PIT
THK	THICKNESS
TJ	TRAVERSE JOINT
TOW	TOP OF WALL
TW	TRADE WASTE
TYP	TYPICAL
U/G	UNDERGROUND
UNO	UNLESS NOTED OTHERWISE
U/S	UPSTREAM
VC	VITRIFIED CLAY PIPE
VP	VENT PIPE
VR	VERTICAL RISER
W	WIDTH
WC	WATER CLOSET
WL	WATER LEVEL
WM	WATER METER
WS	WASTE STACK
UNITS	
	MILLIMETRES
mm	
cm	CENTIMETRES
m	METRES

m

m

L/s

ha

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DESIGN INTENT AND SCOPE OF WORKS	DWG IN COLOUR	
REQUIRED FOR THE INSTALLATION OF SERVICES	DWGINCOLOUR	
AS DETAILED, AND PERTAINED WITHIN THE		
SPECIFICATION AND SHOULD BE READ IN		
CONJUNCTION WITH THE ARCHITECTURAL		
SPECIFICATION, ASSOCIATED SPECIFICATION,		
CODES AND STANDARDS. ALL DIMENSIONS,		
EVELS AND EXISTING SERVICES SHALL BE		
NVESTIGATED AND CONFIRMED ON SITE BY THE		
SUBCONTRACTOR AND BUILDER PRIOR TO THE		
COMMENCEMENT OF ANY WORKS.		

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D	LEC AMENDMENTS	01.05.25	K.B.		BROA
С	COUNCIL AMENDMENTS - S34 OUTCOMES	28.11.24	K.B.		-
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А	ISSUED FOR DA APPROVAL	02.02.24	K.B.		07 55
REV	DESCRIPTION	DATE	APPV'D	ENDO'D	

ITECT: ARCHITECTS Box 308 OAD BEACH QLD 4218 @bdaarch.com.au 555 2600

LOCATION PLAN (NTS)

### LINETYPES & SYMBOLS

GENERAL				
SITE BOUNDARY				
CADASTRAL BOUNDARY				
EASEMENT BOUNDARY				
EXISTING FEATURES				
CONTOURS		3	0	
STORMWATER PIPE				
STORMWATER PIT				
ELECTRICAL CABLE - U/G		— — E —		- — E —
ELECTRICAL CABLE - O/H			— OHE-	
EXISTING SEWER PIPE		— — S —		- — S —
EXISTING WATER		—— w—		- — W-
EXISTING WATER (HYDRANT)				
EXISTING WATER (STOP VALVE)		$\rangle$	$\langle$	
EXISTING TELECOM			— 0FC-	
COMMUNICATIONS PIT				
EXISTING GAS		— — G —		- — G —
EXISTING BUILDING				
TREES / SHRUBS	$\bigcirc$	Ð	÷.	
PROPOSED - BUILDING (INDICATIV	E ON	LY)		
DWELLING NUMBER		UNI	T 01	
FINISHED FLOOR LEVEL		FFL	5.00	
BUILDING FOOTPRINT				

PROPOSED - UTILITIES	
SEWER	S S
WATER	——— w——— w———
COMMUNICATIONS	T T
COMMUNICATIONS - OPTIC FIBRE	0FC 0FC
COMMUNICATIONS PIT	
GAS	G G
ELECTRICAL CABLE - U/G	E E
ELECTRICAL CABLE - O/H	OHE OHE
REDUNDANT	$(1-1)^{-1} (\mathbf{X}_{i} + \mathbf{X}_{i} + \mathbf{X}_{i} + \mathbf{X}_{i} + \mathbf{X}_{i} + \mathbf{X}_{i})$
PROPOSED - EROSION AND SEDIM	IENT CONTROL
SITE EXCLUSION FENCE	[X] [X]
SEDIMENT FENCE	
DIVERSION DRAIN	_>_>
STABLISED SITE ACCESS	
MATERIAL STOCKPILE	· / / / / / / / / / / / / / / / / / / /
SLOPE DIRECTION	>
GEOTEXTILE INLET FILTER	$\boxtimes$
MESH AND GRAVEL INLET FILTER	
SANDBAG / HAY BALES	
PROPOSED CONTOURS	
MAJOR CONTOUR INTERVAL	10
MINOR CONTOUR INTERVAL	

DRAWING NUMBER	DRAWING DESCRIPTION
C01.01	LEGEND, DRAWING SCHEDULE AND LOCATION PLAN
C02.01	GENERAL NOTES
C03.01	EROSION & SEDIMENTATION CONTROL PLAN
C03.02	EROSION & SEDIMENTATION CONTROL DETAILS
C04.01	GENERAL ARRANGEMENT PLAN
C04.02	BULK EARTHWORKS PLAN
C04.03	ROAD PLAN (1 OF 3)
C04.04	ROAD PLAN (2 OF 3)
C04.05	ROAD PLAN (3 OF 3)
C04.06	ROAD 1-8-2 AND 9 LONGITUDINAL SECTIONS (1 of 4)
C04.07	ROAD 1-8-2 AND 9 LONGITUDINAL SECTIONS (2 of 4)
C04.08	ROAD 1-8-2 AND 9 LONGITUDINAL SECTIONS (3 of 4)
C04.09	ROAD 1-8-2 AND 9 LONGITUDINAL SECTIONS (4 of 4)
C04.10	ROAD 6-2 AND 3 LONGITUDINAL SECTIONS (1 of 2)
C04.11	ROAD 6-2 AND 3 LONGITUDINAL SECTIONS (2 of 2)
C04.12	ROAD 4 AND 5 LONGITUDINAL SECTIONS
C04.13	NORTH-SOUTH ROAD AND VISITOR PARKING ACCESS DR. LONGITUDINAL SECTIONS
C05.01	EXISTING STORMWATER CATCHMENT PLAN
C05.02	DEVELOPED STORMWATER CATCHMENT PLAN
C05.03	STORM WATER MANAGEMENT PLAN (1 OF 3)
C05.04	STORM WATER MANAGEMENT PLAN (2 OF 3)
C05.05	STORM WATER MANAGEMENT PLAN (3 OF 3)
C06.01	SITE TYPICAL ROAD SECTIONS
C06.02	ON-SITE DETENTION BASIN No. 1 PLAN
C06.03	ON-SITE DETENTION BASIN No. 1 TYPICAL SECTIONS
C06.04	ON-SITE DETENTION TANK No. 2 PLAN
C06.05	ON-SITE DETENTION TANK No. 2 TYPICAL SECTIONS

PROPOSED - STORMWATER
SW PIPE
(INCL. DIA/GRADE/LENGTH)
SW PIPE - CHARGED
(INCL. DIA/GRADE/LENGTH)
SW PIT - GRATED / JUNCTIO
SW - KERB INLET PIT (INCLUDING LINTEL)
RAINWATER/REUSE TANK
GROSS POLLUTANT TRAP
GRATED DRAIN
INFILTRATION TRENCH
HEADWALL
SUBSOIL
SW SWALE
PIPE RISER
PIPE DROPPER
OVERLAND FLOW PATH
SW PIT NUMBER
SW CATCHMENT (NUMBER / AREA IN ha)

CLIENT: Commercial 7 Pty Ltd ATF Commercial 7 Unit Trust PO Box 1138 HUNTERS HILL NSW 2110




WALLACE INFRASTRUCTURE | CIVIL WORKS for **DESIGN PTY LTD** 


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PROJECT: LOT 225, DP 246447 34 WYNDELLA ROAD LOCHINVAR NSW 2321



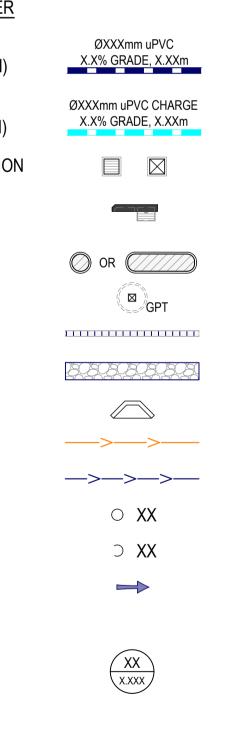

**PROPOSED - CIVIL** CONCRETE ASPHALTIC CONCRETE SAND EARTH RIP RAP **BUILDING / STRUCTURES** TIMBER BLOCK PAVERS **RETAINING WALL** KERB RAMP VEHICULAR CROSSING FENCE BATTER BOLLARD - TYPE 1 (FIXED) BOLLARD - TYPE 2 (REMOVABLE) LINEMARKING - CHEVRON **EXPANSION JOINT** TRAVERSE JOINT CONTROL JOINT FINISHED GRADE LEVELS EXISTING GRADE LEVELS

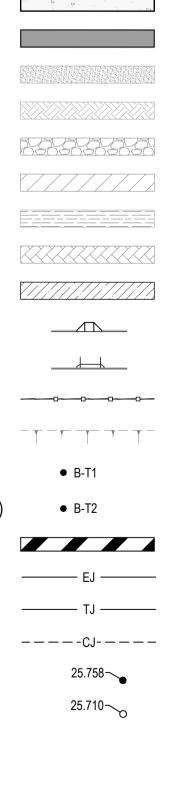

DRAWING TITLE: CIVIL SERVICES	DRAWING STATUS DA APPROVAL NOT TO BE USED FOR CONSTRUCTION					
LEGEND, DRAWING SCHEDULE AND LOCATION PLAN	SCALE: N.T.S.			ORIG. SIZE		
	DRAWN	DESIGNED	CHECKED	APPROVED	ENDORSED	DATE
	MS	KB	AS	KB		01.05.25
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GEI	NERAL NOTES
<u> </u>	ALL CONSTRUCTION WORKS ARE TO BE CARRIED OUT IN ACCORDANCE WITH COUNCIL'S
	ENGINEERING REQUIREMENTS FOR DEVELOPMENTS.
2.	ALL DIMENSIONS, EASEMENTS AND LOTS SUBJECT TO REGISTRATION OF DEPOSITED PLAN.
3.	THESE DRAWINGS ARE TO BE READ IN CONJUNCTION WITH ALL ARCHITECTURAL AND
0.	CONSULTANT'S DRAWINGS AND SPECIFICATIONS, AND OTHER WRITTEN REPORTS (e.g
	GEOTECHNICAL, ARBORIST, ENVIRONMENTAL, ETC.). ANY DISCREPANCY SHALL BE REFERRED
	TO THE ENGINEER BEFORE PROCEEDING WITH ANY WORKS.
4.	ALL LEVELS SHALL BE OBTAINED FROM ESTABLISHED BENCH MARKS AS DIRECTED BY THE
	SUPERVISOR.
5.	THE DEVELOPER, SHALL ENSURE ALL ASSOCIATED DOCUMENTATION (GEOTECHNICAL,
<u> </u>	LANDSCAPE, ARCHITECTURAL, ELECTRICAL, TELECOM, GAS ETC.) HAS BEEN APPROVED FOR
	CONSTRUCTION BEFORE COMMENCING ANY WORKS.
6.	THE CONTRACTOR IS RESPONSIBLE FOR THE LOCATION, PROTECTION AND ADJUSTMENT TO
	ALL IN GROUND AND ABOVE GROUND SERVICES. SEE HUNTER WATER'S NOTICE OF
	REQUIREMENTS.
7.	EROSION CONTROL MEASURES, DEVICES, SILT TRAPS. ETC. ARE TO BE INSTALLED BEFORE
	ANY SITE DISTURBANCE IN ACCORDANCE WITH COUNCIL INSPECTORS REQUIREMENTS AND
	SITE SEDIMENTATION AND EROSION CONTROL PLANS.
8.	IT IS THE CONTRACTORS RESPONSIBILITY TO ENSURE THAT ALL WORKS ARE CARRIED OUT IN
	ACCORDANCE WITH THE WORK HEALTH SAFETY ACT.
9.	VEHICULAR ACCESS AND ALL SERVICES ARE TO BE MAINTAINED AT ALL TIMES TO ADJOINING
	PROPERTIES AFFECTED BY CONSTRUCTION WORKS.
10.	ALL WASTE OR DEMOLISHED MATERIALS SHALL BE DISPOSED OF OFF SITE TO A COUNCIL
	APPROVED SITE. ALL FEES AND CHARGES SHALL BE INCLUDED IN THE CONTRACT SUM.
11.	CONSTRUCTION VIBRATION TO COMPLY WITH AS2760.1-2004 AND/OR NSW DEPT OF
	ENVIRONMENT AND CONSERVATION NOISE REQUIREMENTS
12.	EMISSIONS FROM SITE ARE NOT TO INTERFERE WITH THE AMENITY OF THE NEIGHBORHOOD.
13.	NOISE EMISSIONS ARE TO COMPLY WITH NSW EPA NOISE CONTROL MANUAL. TIME
	RESTRICTIONS APPLY TO CONSTRUCTION WORKS AS FOLLOWS: 7AM TO 6PM MON-FRI; 8AM TO
	1PM SAT.
14.	TREES & SHRUBS WHICH ARE FELLED SHALL BE SALVAGED FOR RE-USE, EITHER IN LOG FORM,
	OR AS A WOODCHIP MULCH FOR EROSION CONTROL AND/OR SITE REHABILITATION.
	NON-SALVAGEABLE MATERIAL SUCH AS ROOTS & STUMPS SHALL BE DISPOSED OF IN AN
	APPROVED MANNER.
15.	'ESCP' REFERS TO EROSION AND SEDIMENT CONTROL PLAN, 'SWMP' REFERS TO SOIL AND
	WATER MANAGEMENT PLAN, AND, 'ESC' REFERS TO EROSION AND SEDIMENT CONTROL.
16	

SEDIMENT, INCLUDES, BUT IS NOT LIMITED TO, CLAY, SILT, SAND, GRAVEL, SOIL, MUD, CEMENT

ANY REFERENCE TO THE BLUE BOOK REFERS TO "MANAGING URBAN STORMWATER - SOILS

ANY REFERENCE TO THE IECA WHITE BOOKS (2008) REFERS TO IECA 2008, "BEST PRACTICE

ANY MATERIAL DEPOSITED IN ANY CONSERVATION AREA FROM WORKS ASSOCIATED WITH THE

DEVELOPMENT SHALL BE REMOVED IMMEDIATELY BY MEASURES INVOLVING MINIMAL GROUND

AND/OR VEGETATION DISTURBANCES AND NO MACHINERY, OR FOLLOWING DIRECTIONS BY

THE EXISTING SURVEY CONDITIONS SHOWN ON THESE DRAWINGS HAVE BEEN DERIVED FROM

SURVEY INFORMATION SUPPLIED BY DeWITT CONSULTING ENGINEERS, DATED AUGUST 2023,

THE INFORMATION SHOWN IS PROVIDED AS A BASIS FOR THE DESIGN. WALLACE DESIGN GROUP

DOES NOT GUARANTEE THE ACCURACY OR COMPLETENESS OF THE SURVEY BASE OR ITS

SHOULD DISCREPANCIES BE ENCOUNTERED DURING CONSTRUCTION BETWEEN THE SURVEY

DATA AND ACTUAL FIELD DATA, CONTRACTOR SHALL CONTACT DeWITT CONSULTING.

THE CONTRACTOR SHALL ARRANGE ALL SURVEY SETOUT TO BE CARRIED OUT BY A

THE FOLLOWING SURVEY INFORMATION HAS BEEN TAKEN DIRECTLY FROM THE ORIGINAL

SSM 4168

MGA 56

SUITABILITY AS A BASIS FOR CONSTRUCTION DRAWINGS.

355270.281

6380990.909

RL: 35.273 (AHD)

EROSION AND SEDIMENT CONTROL". BOOKS 1-6. INTERNATIONAL EROSION CONTROL

16.

17.

18.

19.

4.

SURVEY NOTES

REF NO. 14576.

SURVEY DOCUMENTS:

EASTING:

NORTHING:

POSITION DATUM:

**ORIENTATION:** 

HEIGHT DATUM:

**REGISTERED SURVEYOR.** 

AND CERAMIC WASTE

AND CONSTRUCTION", LANDCOM, 2004.

ASSOCIATION (AUSTRALASIA), PICTON, NSW.

COUNCIL AND/OR WITHIN A TIMEFRAME ADVISED BY COUNCIL.

- THE ESCP
- THE ESCP AND ITS ASSOCIATED ESC MEASURES SHALL BE CONSTANTLY MONITORED, REVIEWED AND MODIFIED AS REQUIRED TO CORRECT DEFICIENCIES. COUNCIL HAS THE RIGHT TO DIRECT CHANGES IF, IN ITS OPINION, THE MEASURES THAT ARE PROPOSED OR HAVE BEEN INSTALLED ARE INADEQUATE TO PREVENT POLLUTION.
- PRIOR TO ANY ACTIVITIES ONSITE, THE RESPONSIBLE PERSON(S) IS TO BE NOMINATED. THE 2. RESPONSIBLE PERSON(S) SHALL BE RESPONSIBLE FOR THE ESC MEASURES ONSITE. THE NAME, ADDRESS AND 24 HOUR CONTACT DETAILS OF THE PERSON(S) SHALL BE PROVIDED TO COUNCIL IN WRITING. COUNCIL SHALL BE ADVISED WITHIN 48 HOURS OF ANY CHANGES TO THE RESPONSIBLE PERSON(S), OR THEIR CONTACT DETAILS, IN WRITING
- AT LEAST 14 DAYS BEFORE THE NATURAL SURFACE IS DISTRIBUTED IN ANY NEW STAGE, THE 3. CONTRACTOR SHALL SUBMIT TO THE CERTIFIER A PLAN SHOWING ESC MEASURES FOR THAT STAGE. THE DEGREE OF DESIGN DETAIL SHALL BE BASED ON THE DISTRIBUTED AREA.
- AT ANY TIME, THE ESC MEASURES ONSITE SHALL BE APPROPRIATE FOR THE AREA OF 4 DISTURBANCE AND ITS CHARACTERISTICS, INCLUDING SOIL TYPE (IN ACCORDANCE WITH THOSE REQUIRED FOR THE SITE AS PER THE DCP)
- THE IMPLEMENTATION OF THE ESCP SHALL BE SUPERVISED BY PERSONNEL WITH 5 APPROPRIATE QUALIFICATIONS AND/OR EXPERIENCE IN ESC ON CONSTRUCTION SITES. 6. THE APPROVED ESCP SHALL BE AVAILABLE ON-SITE FOR INSPECTION BY COUNCIL OFFICERS
- WHILE WORK ACTIVITIES ARE OCCURRING.
- THE APPROVED ESCP SHALL BE UP TO DATE AND SHOW A TIMELINE OF INSTALLATION. MAINTENANCE AND REMOVAL OF ESC MEASURES. 8.
- ALL ESC MEASURES SHALL BE APPROPRIATE FOR THE SEDIMENT TYPE(S) OF THE SOILS ONSITE, IN ACCORDANCE WITH THE BLUE BOOK, IECA WHITE BOOKS OR OTHER CURRENT RECOGNISED INDUSTRY STANDARDS PERTAINING TO ESC FOR AUSTRALIAN CONDITIONS.
- ADEQUATE SITE DATA, INCLUDING SOIL DATA FROM A NATA APPROVED LABORATORY, SHALL BE 9. OBTAINED TO ALLOW FOR THE PREPARATION OF AN APPROPRIATE ESCP. AND TO ALLOW FOR THE SELECTION, DESIGN AND SPECIFICATION OF REQUIRED ESC MEASURES.
- ALL WORK SHALL BE CARRIED OUT IN ACCORDANCE WITH THE APPROVED ESCP (AS AMENDED 10. FROM TIME TO TIME) UNLESS CIRCUMSTANCES ARISE WHERE A) COMPLIANCE WITH THE ESCP WOULD INCREASE THE POTENTIAL FOR ENVIRONMENTAL HARM B) CIRCUMSTANCES CHANGE DURING CONSTRUCTION AND THOSE CIRCUMSTANCES COULD NOT HAVE BEEN FORSEEN: OR C) COUNCIL DETERMINES THAT UNACCEPTABLE OFF-SITE SEDIMENTATION IS OCCURRING AS A RESULT OF A LAND-DISTURBING ACTIVITY. IN EITHER CASE, THE PERSON(S) RESPONSIBLE MAY BE REQUIRED TO TAKE ADDITIONAL, OR ALTERNATIVE PROTECTIVE ACTION, AND/OR UNDERTAKE REASONABLE RESTORATION WORKS WITHIN THE TIMEFRAME SPECIFIED BY THE

COUNCIL.

- ADDITIONAL ESC MEASURES SHALL BE IMPLEMENTED, AND A REVISED ESCP SUBMITTED FOR 11. APPROVAL TO THE CERTIFIER (WITHIN 5 BUSINESS DAYS OF AN SUCH AMENDMENTS) IN THE EVENT THAT:
  - A) THERE IS A HIGH PROBABILITY THAT SERIOUS OR MATERIAL ENVIRONMENTAL HARM MAY OCCUR AS A RESULT OF SEDIMENT LEAVING THE SITE; OR B) THE IMPLEMENTED WORKS FAIL TO ACHIEVE COUNCIL'S WATER QUALITY OBJECTIVES SPECIFIED IN THESE CONDITIONS; OR C) SITE CONDITIONS SIGNIFICANTLY CHANGE; OR D) SITE INSPECTIONS INDICATE THAT THE IMPLEMENTED WORKS ARE FAILING TO ACHIEVE THE
- "OBJECTIVE" OF THE ESCP. 12. A COPY OF ANY AMENDED ESCP SHALL BE FORWARDED TO AN APPROPRIATE COUNCIL OFFICER. WITHIN FIVE BUSINESS DAYS OF ANY SUCH AMENDMENTS.

### SITE ESTABLISHMENT INCLUDING CLEARING AND MULCHING

- NO LAND CLEARING SHALL BE UNDERTAKEN UNLESS PRECEDED BY THE INSTALLATION OF ADEQUATE DRAINAGE AND SEDIMENT CONTROL MEASURES. UNLESS SUCH CLEARING IS REQUIRED FOR THE PURPOSE OF INSTALLING SUCH MEASURES. IN WHICH CASE. ONLY THE MINIMUM CLEARING REQUIRED TO INSTALL SUCH MEASURES SHALL OCCUR. BULK TREE CLEARING AND GRUBBING OF THE SITE SHALL BE IMMEDIATELY FOLLOWED BY SPECIFIED TEMPORARY EROSION CONTROL MEASURES (E.G. TEMPORARY GRASSING OR MULCHING) PRIOR TO THE COMMENCEMENT OF EACH STAGE OF CONSTRUCTION WORKS.
- TREES AND VEGETATION CLEARED FROM THE SITE SHALL BE MULCHED ONSITE WITHIN 7 DAYS 3 OF CLEARING.
- APPROPRIATE MEASURES SHALL BE UNDERTAKEN TO CONTROL ANY DUST ORIGINATING DUE 4. TO THE MULCHING OF VEGETATION ONSITE.
- 5. ALL OFFICE FACILITIES AND OPERATIONAL ACTIVITIES SHALL BE LOCATED SUCH THAT ANY EFFLUENT. INCLUDING WASH-DOWN WATER. CAN BE TOTALLY CONTAINED AND TREATED WITHIN THE SITE.
- 6 ALL REASONABLE AND PRACTICABLE MEASURES SHALL BE TAKEN TO ENSURE STORMWATER RUNOFF FROM ACCESS ROADS AND STABILISED ENTRY/EXIT SYSTEMS DRAINS TO AN APPROPRIATE SEDIMENT CONTROL DEVICE.
- SITE EXIT POINTS SHALL BE APPROPRIATELY MANAGED TO MINIMISE THE RISK OF SEDIMENT 7. BEING TRACKED ONTO SEALED, PUBLIC ROADWAYS.
- STORMWATER RUNOFF FROM ACCESS ROADS AND STABILIZED ENTRY/EXIT POINTS SHALL 8. DRAIN TO AN APPROPRIATE SEDIMENT CONTROL DEVICE. THE APPLICANT SHALL ENSURE AN ADEQUATE SUPPLY OF ESC, AND APPROPRIATE POLLUTION 9 CLEAN-UP MATERIALS ARE AVAILABLE ON-SITE AT ALL TIMES.
- 10. ALL TEMPORARY EARTH BANKS, FLOW DIVERSION SYSTEMS, AND SEDIMENT BASIN EMBANKMENTS SHALL BE MACHINE-COMPACTED, SEEDED AND MULCHED WITHIN 10 DAYS OF FORMATION FOR THE PURPOSE OF ESTABLISHING A VEGETATIVE COVER, OR LINED APPROPRIATELY.
- 11. SEDIMENT DEPOSITED OFF SITE AS A RESULT OF ON--SITE ACTIVITIES SHALL BE COLLECTED AND THE AREA CLEANED/REHABILITATED AS SOON AS REASONABLE AND PRACTICABLE. 12. CONCRETE WASTE AND CHEMICAL PRODUCTS INCLUDING PETROLEUM AND OIL-BASED PRODUCTS. SHALL BE PREVENTED FROM ENTERING ANY INTERNAL OR EXTERNAL WATER BODY. OR ANY EXTERNAL DRAINAGE SYSTEM, EXCLUDING THOSE ON-SITE WATER BODIES
- SPECIFICALLY DESIGNED TO CONTAIN AND/OR TREAT SUCH MATERIAL. APPROPRIATE

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CODES AND STANDARDS. ALL DIMENSIONS,			В	COUNCIL AMENDMENTS - PREL S34	19.08.24	K.B.		inio@buadicii.com.au
LEVELS AND EXISTING SERVICES SHALL BE INVESTIGATED AND CONFIRMED ON SITE BY THE			A	ISSUED FOR DA APPROVAL	02.02.24	K.B.		07 5555 2600
SUBCONTRACTOR AND BUILDER PRIOR TO THE COMMENCEMENT OF ANY WORKS.			REV	DESCRIPTION	DATE	APPV'D	ENDO'D	
PLOTTED BY:- KEN DATE:- 2 May 2025 3 34 PM FILENAME:- O:\PROJECTS\2023\23128 - 34 WYNDELLA ROAD, LOCHINVAR\CAD\TITLE\23128_CIV_DA-[E]_34 WYNDELLA ROAD								

- MEASURES SHALL BE INSTALLED TO TRAP THESE MATERIALS ONSITE.
- BRICK. TILE OR MASONRY CUTTINGS SHALL BE CARRIED OUT ON A PERVIOUS SURFACE (E.G. 13. GRASS OR OPEN SOIL) AND IN SUCH A MANNER THAT ANY RESULTING SEDIMENT-LADEN RUNOFF IS PREVENTED FROM DISCHARGING INTO A GUTTER, DRAIN OR WATER. APPROPRIATE MEASURES SHALL BE INSTALLED TO TRAP THESE MATERIALS ONSITE.
- NEWLY SEALED HARD-STAND AREAS (E.G. ROADS, DRIVEWAYS AND CAR PARKS) SHALL BE 14. SWEPT THOROUGHLY AS SOON AS PRACTICABLE AFTER SEALING/SURFACING TO MINIMISE THE
- RISK OF COMPONENTS OF THE SURFACING COMPOUND ENTERING THE STORMWATER DRAINS. STOCKPILES OF ERODIBLE MATERIAL SHALL BE PROVIDED WITH AN APPROPRIATE PROTECTIVE 15. COVER (SYNTHETIC OR ORGANIC) IF THE MATERIALS ARE LIKELY TO BE STOCKPILED FOR MORE THAN 10 DAYS.
- 16. STOCKPILES, TEMPORARY OR PERMANENT, SHALL NOT BE LOCATED IN AREAS IDENTIFIED AS NO-GO ZONES (INCLUDING, BUT NOT LIMITED TO, RESTRICTED ACCESS AREAS, BUFFER ZONES, OR AREAS OF NON-DISTURBANCE) ON THE ESCP.
- 17. NO MORE THAN 150m OF STORMWATER, SEWER LINE OR OTHER SERVICE TRENCH SHALL BE TO OPEN AT ANY ONE TIME.
- SITE SPOIL SHALL BE LAWFULLY DISPOSED OF IN A MANNER THAT DOES NOT RESULT IN 18. ONGOING SOIL EROSION OR ENVIRONMENTAL HARM.
- 19. WHEREVER REASONABLE AND PRACTICABLE, STORMWATER RUNOFF ENTERING THE SITE FROM EXTERNAL AREAS, AND NON-SEDIMENT LADEN (CLEAN) STORMWATER RUNOFF ENTERING A WORK AREA OR AREA OF SOIL DISTURBANCE, SHALL BE DIVERTED AROUND OR THROUGH THAT AREA IN A MANNER THAT MINIMISES SOIL EROSION AND THE CONTAMINATION OF THAT WATER FROM ALL DISCHARGES UP TO THE SPECIFIED DESIGN STORM DISCHARGE.

### SITE MANAGEMENT INCLUDING DUST

- PRIORITY SHALL BE GIVEN TO THE PREVENTION, OR AT LEAST THE MINIMISATION, OF SOIL EROSION, RATHER THAN THE TRAPPING OF DISPLACED SEDIMENT, SUCH A CLAUSE SHALL NOT REDUCE THE RESPONSIBILITY TO APPLY AND MAINTAIN, AT ALL TIMES, ALL NECESSARY ESC MEASURES.
- MEASURES USED TO CONTROL WIND EROSION SHALL BE APPROPRIATE FOR THE LOCATION 2 AND PREVENT SOIL EROSION AND EMISSIONS FROM SITE AT ALL TIMES. INCLUDING WORKING HOURS, OUT OF HOURS, WEEKENDS, PUBLIC HOLIDAYS, AND DURING ANY OTHER SHUTDOWN PERIODS.
- THE APPLICATION OF LIQUID OR CHEMICAL-BASED DUST SUPPRESSION MEASURES SHALL ENSURE THAT SEDIMENT-LADEN RUNOFF RESULTING FROM SUCH MEASURES DOES NOT CREATE A TRAFFIC OR ENVIRONMENTAL HAZARD.
- ALL CUT AND FILL EARTH BATTERS LESS THAN 3m IN ELEVATION SHALL BE TOPSOILED, AND 4 GRASS SEEDED/HYDROMULCHED WITHIN 10 DAYS OF COMPLETION OF GRADING IN CONSULTATION WITH COUNCIL.
- ALL DISTURBED AREAS SHALL BE STABILISED IN ACCORDANCE WITH TIMELINES IN THE BLUE 5. BOOK.
- ALL REASONABLE AND PRACTICABLE MEASURES SHALL BE TAKEN TO PREVENT, OR AT LEAST MINIMISE, THE RELEASE OF SEDIMENT FROM THE SITE.
- SUITABLE ALL-WEATHER MAINTENANCE ACCESS SHALL BE PROVIDED TO ALL SEDIMENT CONTROL DEVICES.
- SEDIMENT CONTROL DEVICES OTHER THAN SEDIMENT BASINS SHALL BE DE-SILTED AND MADE FULLY OPERATIONAL AS SOON AS REASONABLE AND PRACTICABLE AFTER A SEDIMENT-PRODUCING EVENT, WETHER NATURAL OR ARTIFICIAL, IF THE DEVICES SEDIMENT RETENTION CAPACITY FALLS BELOW 75% OF ITS DESIGNED RETENTION CAPACITY.
- ALL EROSION AND SEDIMENT CONTROL MEASURES, INCLUDING DRAINAGE CONTROL MEASURES. SHALL BE MAINTAINED IN PROPER WORKING ORDER AT ALL TIMES DURING THEIR **OPERATION LIVES.**
- WASHING/FLUSHING OF SEALED ROADWAYS SHALL ONLY OCCUR WHERE SWEEPING HAS 10. FAILED TO REMOVE SUFFICIENT SEDIMENT AND THERE IS A COMPELLING NEED TO REMOVE THE REMAINING SEDIMENT (E.G. FOR SAFETY REASONS). IN SUCH CIRCUMSTANCES, ALL REASONABLE AND PRACTICABLE SEDIMENT CONTROL MEASURES SHALL BE USED TO PREVENT, OR AT LEAST MINIMISE, THE RELEASE OF SEDIMENT INTO THE RECEIVING WATERS. ONLY THOSE MEASURES THAT WILL NOT CAUSE SAFETY AND PROPERTY FLOODING ISSUES SHALL BE EMPLOYED. SEDIMENT REMOVED FROM ROADWAYS SHALL BE DISPOSED OF IN A LAWFUL MANNER THAT DOES NOT CAUSE ONGOING SOIL EROSION OR ENVIRONMENTAL HARM.
- SEDIMENT REMOVED FROM SEDIMENT TRAPS AND PLACES OF SEDIMENT DEPOSITIONS SHALL 11. BE DISPOSED OF IN A LAWFUL MANNER THAT DOES NOT CAUSE ONGOING SOIL EROSION OR ENVIRONMENTAL HARM.

### **REVEGETATION/STABILISATION**

- TEMPORARY STABILISATION MAY BE ATTAINED USING VEGETATION, NON WETTABLE SOIL POLYMERS, OR PNEUMATICALLY APPLIED EROSION CONTROLS.
- ALL CUT AND FILL EARTH BATTERS LESS THAN 3m IN ELEVATION SHALL BE TOPSOILED, AND 2. GRASS SEEDED/HYDROMULCHED WITHIN 10 DAYS OF COMPLETION OF GRADING IN CONSULTATION WITH COUNCIL.
- AT THE COMPLETION OF FORMATION IN ANY SECTION, ALL DISTRIBUTED AREAS SHALL BE STABILISED IN ACCORDANCE WITH TIME LINES IN THE BLUE BOOK.
- THE COUNCIL SEED MIX SHALL BE USED UNLESS STATED ON THE ESCP/SWMP.
- THE PH LEVEL OF TOPSOIL SHALL BE APPROPRIATE TO ENABLE ESTABLISHMENT AND GROWTH OF SPECIFIED VEGETATION PRIOR TO INITIATING THE ESTABLISHMENT OF VEGETATION.
- NON REWETTABLE BINDER SHALL BE USED IN ALL HYDROMULCH/HYDROSEED POLYMER MIXES 6. ON SLOPES OR WORKS ADJACENT TO A WATER COURSE.
- SOIL AMELIORANTS SHALL BE ADDED TO THE SOIL IN ACCORDANCE WITH AN APPROVED 7. LANDSCAPE PLAN, VEGETATION MANAGEMENT PLAN, AND/OR SOIL ANALYSIS.
- PROCEDURES FOR INITIATING A SITE SHUTDOWN, WHETHER PROGRAMMED OR UN-PROGRAMMED, SHALL INCORPORATE REVEGETATION OF ALL SOIL DISTURBANCES UNLESS OTHERWISE APPROVED BY COUNCIL. THE STABILISATION WORKS SHALL NOT RELY UPON THE LONGEVITY OF NON-VEGETATED EROSION CONTROL BLANKETS, OR TEMPORARY SOIL BINDERS.

### Commercial 7 Pty Ltd ATF Commercial 7 Unit Trust PO Box 1138 HUNTERS HILL NSW 2110



WALLACE DESIGN GROUP

### WALLACE INFRASTRUCTURE **DESIGN PTY LTD**

PART OF WALLACE DESIGN GROUP PTY LTD ABN: 96 154 894 952 PO BOX 23, CHARLESTOWN, NSW 2290 phone: (02) 49 294 109

PROJECT CIVIL WORKS for LOT 225, DP 246447 34 WYNDELLA ROAD LOCHINVAR NSW 2321

web: www.wdegroup.com.au

### SITE MONITORING AND MAINTENANCE

- THE APPLICANT SHALL ENSURE THAT APPROPRIATE PROCEDURES AND SUITABLY QUALIFIED PERSONNEL ARE ENGAGED TO PLAN AND CONDUCT SITE INSPECTIONS AND WATER QUALITY MONITORING THROUGHOUT THE CONSTRUCTION AND MAINTENANCE PHASE.
- ALL ESC MEASURES SHALL BE INSPECTED AND ANY MAINTENANCE UNDERTAKEN:
- A) AT LEAST DAILY (WHEN WORKS IS OCCURRING ON-SITE); AND B) AT LEAST WEEKLY (WHEN WORKS IS NOT OCCURRING ON-SITE) AND
- C) WITHIN 24 HOURS OF EXPECTED RAINFALL; AND
- D) WITHIN 18 HOURS OF A RAINFALL EVENT THAT CAUSES RUNOFF ON THE SITE.
- WRITTEN RECORDS SHALL BE KEPT ONSITE OF ESC MONITORING AND MAINTENANCE ACTIVITIES CONDUCTED DURING THE CONSTRUCTION AND MAINTENANCE PERIODS, AND BE AVAILABLE TO COUNCIL OFFICERS ON REQUEST.
- ALL ENVIRONMENTAL RELEVANT INCIDENTS SHALL BE RECORDED IN A FIELD LOG THAT SHALL 4 REMAIN ACCESSIBLE TO ALL RELEVANT REGULATORY AUTHORITIES.
- ALL WATER QUALITY DATA, INCLUDING DATES OF RAINFALL, DATES OF TESTING, TESTING RESULTS AND DATES OF WATER RELEASE, SHALL BE KEPT IN AN ON-SITE REGISTER. THE REGISTER IS TO BE MAINTAINED UP TO DATE FOR THE DURATION OF THE APPROVED WORKS AND BE AVAILABLE ON-SITE FOR INSPECTION BY ALL RELEVANT REGULATORY AUTHORITIES ON REQUEST.
- AT NOMINATED INSTREAM WATER MONITORING SITES. A MINIMUM OF 3 WATER SAMPLES SHALL BE TAKEN AND ANALYSED, AND THE AVERAGE RESULT USED TO DETERMINE QUALITY.

### STORMWATER NOTES

- THESE DRAWINGS ARE TO BE READ IN CONJUNCTION WITH RELEVANT ARCHITECTURAL DETAILS.
- ALL WORKS ARE TO BE IN ACCORDANCE WITH AS3500, COUNCIL'S DEVELOPMENT CONTROL 2. PLAN AND PROPRIETARY MANUFACTURERS RECOMMENDATIONS.
- UNLESS OTHERWISE STATED, ALL STORMWATER PIPES (INCLUDING DOWNPIPES AND RAINWATER TANK OVERFLOW PIPES) ARE TO BE uPVC SEWER GRADE, U.N.O JOINTED & INSTALLED TO MANUFACTURERS RECOMMENDATIONS.
- ALL uPVC STORMWATER LINES TO HAVE ALL JOINTS, INC. DOWNPIPE CONNECTIONS, FULLY SOLVENT WELDED, INCLUDING ANY CHARGED LINES.
- CONNECT DOWNPIPES AS REQUIRED TO NOMINATED HARVESTING TANK IN ACCORDANCE WITH APPROVED DEVELOPMENT PLANS AND HYDRAULIC ENGINEERS DESIGN.
- ALL LEVELS ARE DATUM AHD. ALL LEVELS ARE FINISHED PAVEMENT OR LAWN LEVELS.
- CONTRACTOR TO ALLOW FOR ALL PIPE SUPPORT SYSTEM TO SOFFIT AS PER MANUFACTURERS SPECIFICATIONS.
- ALL CONCRETE TO BE MANUFACTURED AND SUPPLIED IN ACCORDANCE WITH AS1379. g 10. AT COUNCILS DISCRETION. ALL CONCRETE CAN BE SUBJECT TO PROJECT ASSESSMENT AND TESTING TO AS1379
- MINIMUM PIPE COVERS TO BE IN ACCORDANCE WITH AS3500. 11.
- PITS TO BE FILLED ACCORDINGLY TO MEET INVERTS AS NEEDED. 12 13. CONTRACTOR TO CONFIRM ALL LEVELS PRIOR TO CONSTRUCTION. ANY DISCREPANCIES ARE TO BE IMMEDIATELY REPORTED TO WALLACE DESIGN GROUP

### SUBSOIL DRAINAGE NOTES

- CONSTRUCTION SHALL BE IN ACCORDANCE WITH COUNCIL'S CONSTRUCTION SPECIFICATIONS FOR SUBSURFACE DRAINAGE.
- SUBSOIL PIPE TO BE Ø100 SLOTTED PVC OR CORRUGATED CIRCULAR PLASTIC PIPE AND ENCLOSED IN SEAMLESS FILTER FABRIC SOCK
- SUBSOIL DRAINS SHALL CONSIST OF A 300 (MINIMUM) WIDE TRENCH, BACKFILLED WITH 7 OR 10mm AGGREGATE AND WRAPPED IN BIDIM A12 GEOTEXTILE FABRIC OR SIMILAR, LAPPED AT THE TOP. DEPTH OF TRENCH TO EXTEND 450 (MINIMUM) IN ROCK OR 600 (MINIMUM) IN EARTH BELOW FINISHED SUB-GRADE LEVEL. INVERT OF TRENCH SHOULD ALSO BE LOWER THAN THE INVERT OF ANY SERVICE CROSSINGS.


### **ROAD/DRIVEWAY PAVEMENT NOTES**

THE PAVEMENT DESIGN RECOMMENDATIONS SHOWN ON THESE DRAWINGS ARE INDICATIVE ONLY, AND ARE TO BE CONFIRMED BEFORE CONSTRUCTION CERTIFICATE STAGE BY A QUALIFIED/REGISTERED GEOTECHNICAL ENGINEER.

### **RETAINING WALL NOTES**

ALL RETAINING WALLS SHOWN ON THESE PLANS SHALL BE DESIGNED BY A QUALIFIED & REGISTERED STRUCTURAL ENGINEERING AT TIME OF CONSTRUCTION CERTIFICATE STAGE.

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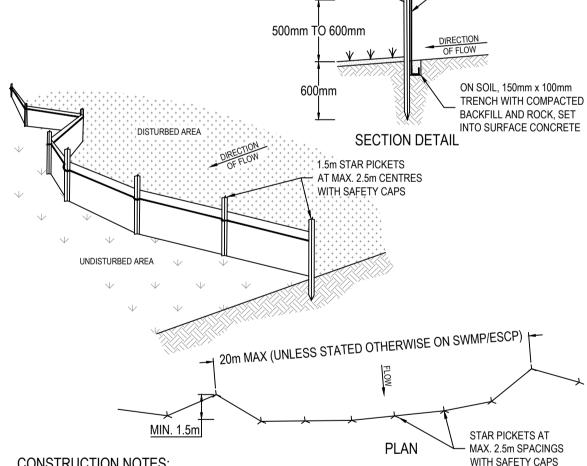
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LEVELS AND EXISTING SERVICES SHALL BE INVESTIGATED AND CONFIRMED ON SITE BY THE	А	ISSUED FOR DA APPROVAL	02.02.24	K.B.		07 5555 2600		
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### SEDIMENT FENCE

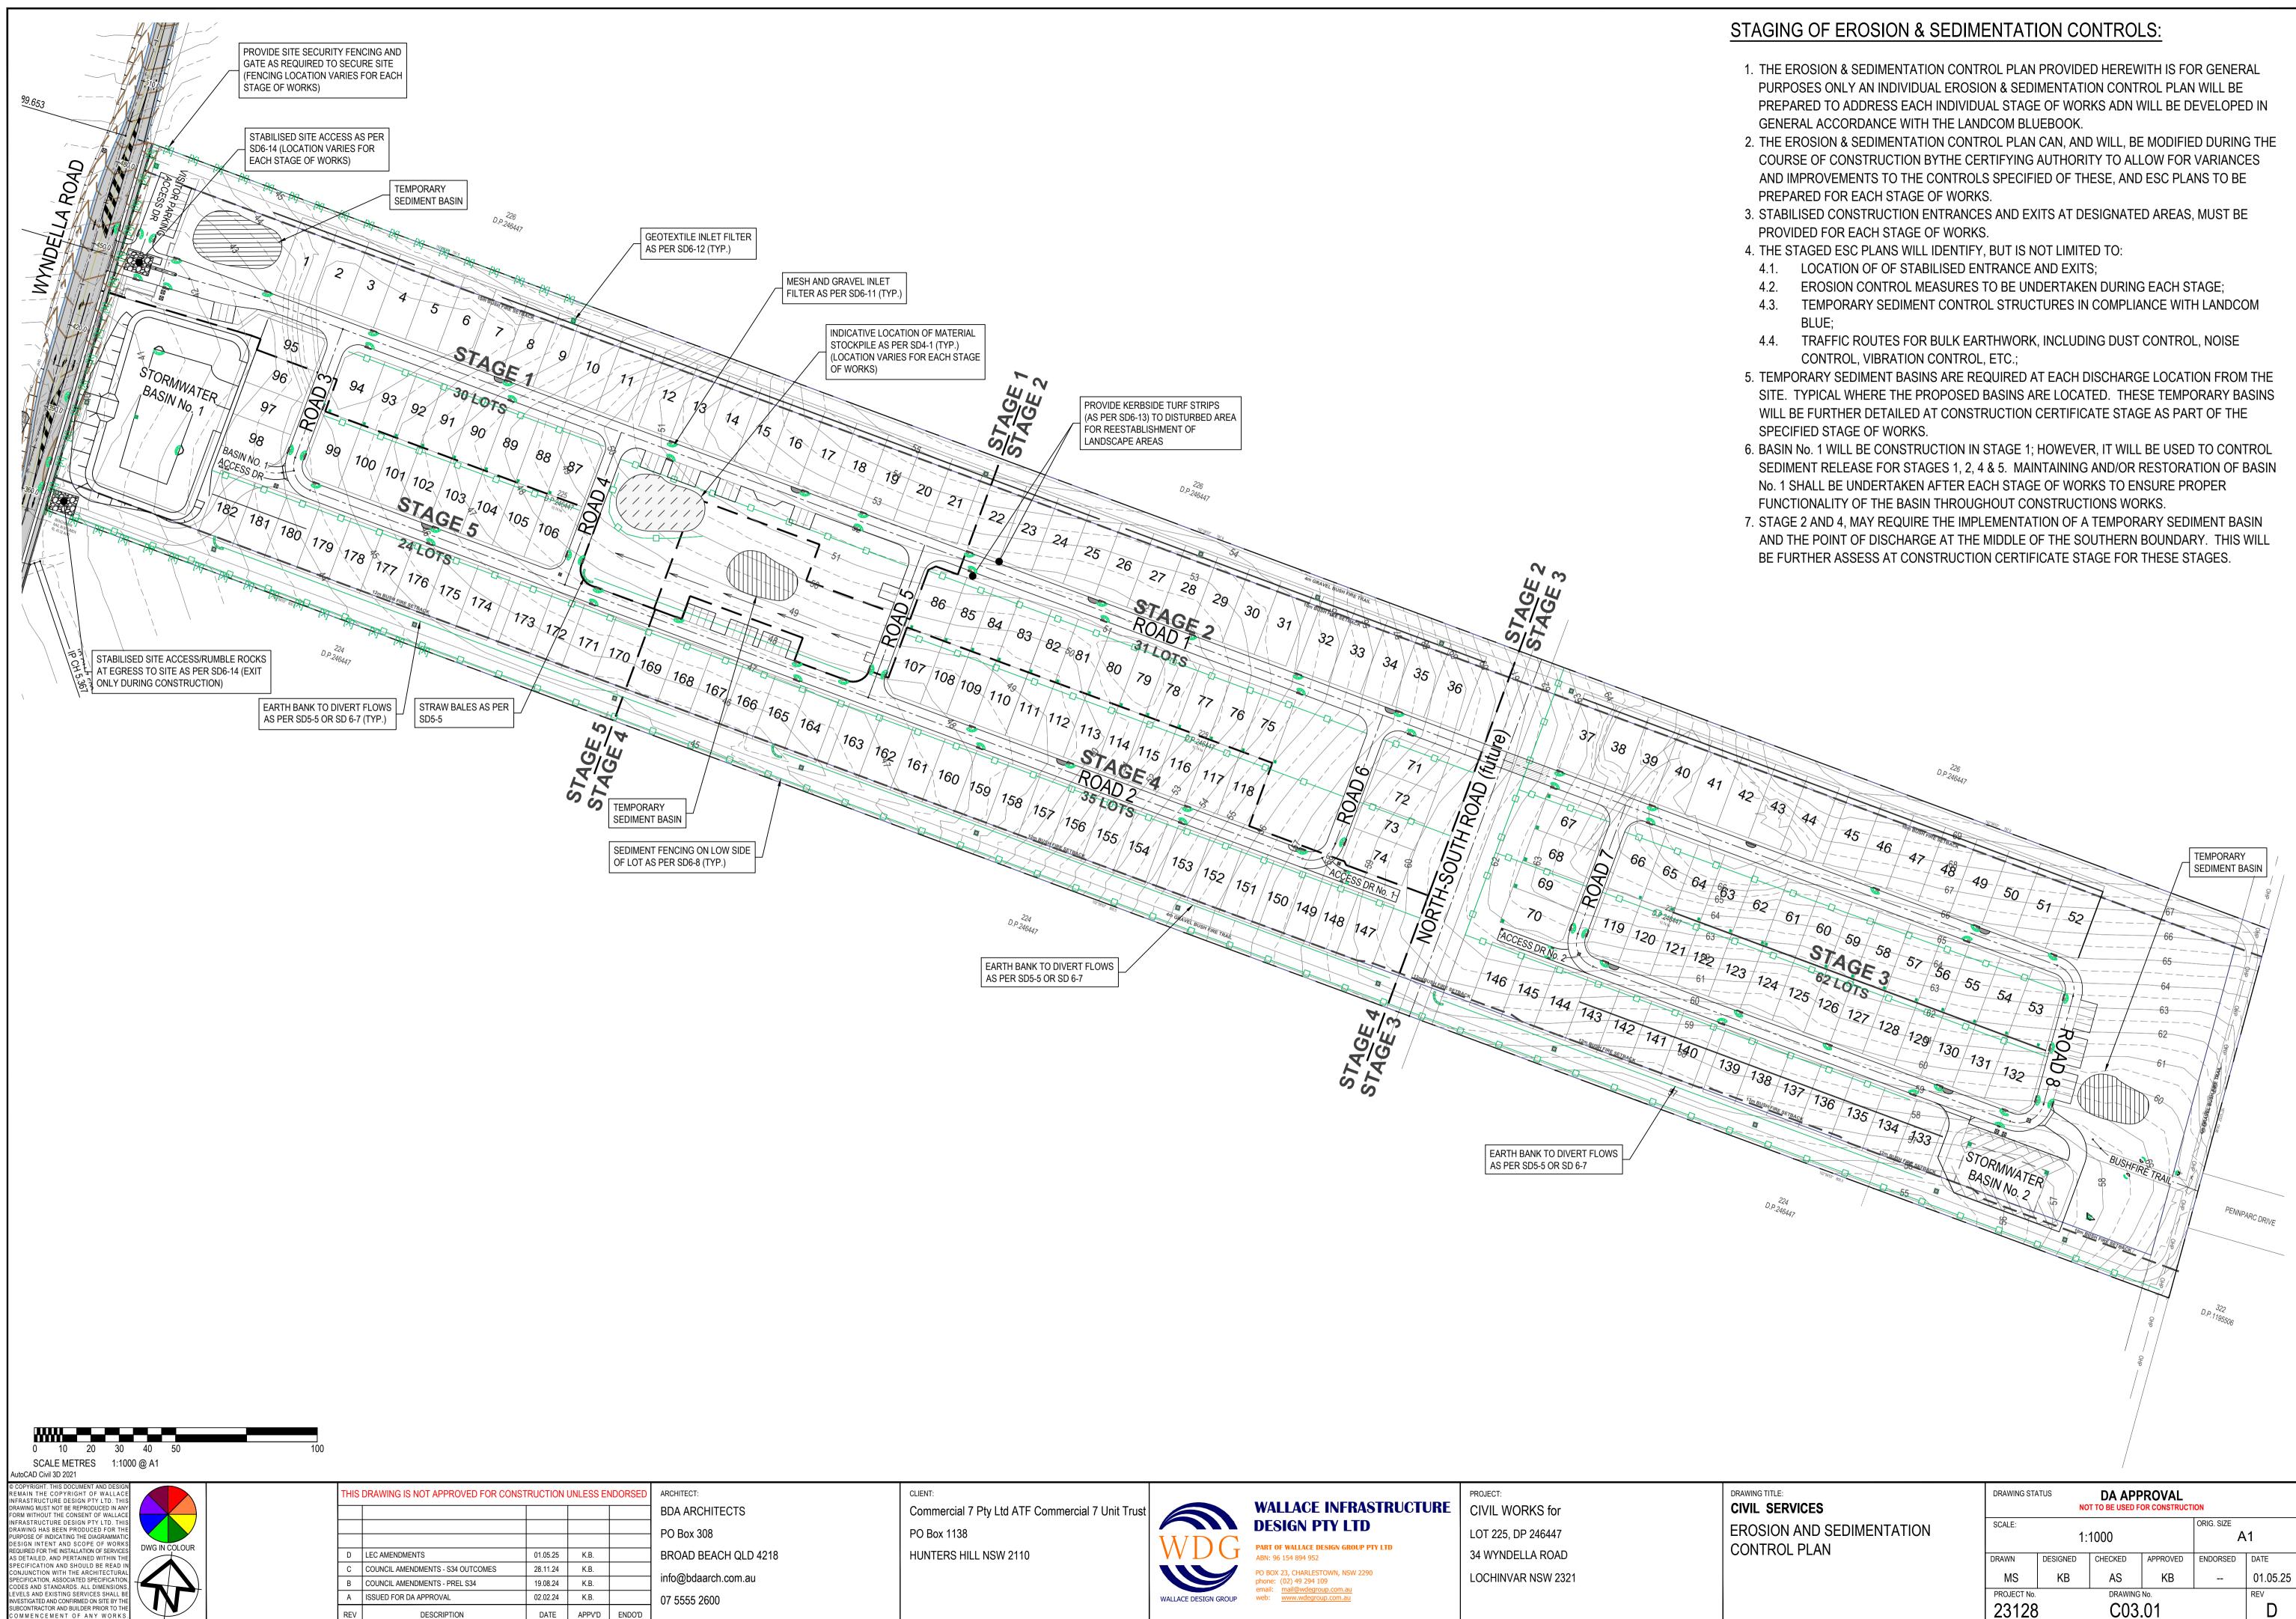- 6. BACKFILL THE TRENCH OVER THE BASE OF THE FABRIC AND COMPACT IT THOROUGHLY OVER THE GEOTEXTILE
- 5. JOIN SECTIONS OF FABRIC AT A SUPPORT POST WITH A 150mm OVERLAP.
- FIX SELF-SUPPORTING GEOTEXTILE TO THE UPSLOPE SIDE OF THE POSTS ENSURING IT GOES TO THE BASE OF THE TRENCH. FIX THE GEOTEXTILE WITH WIRE TIES OR AS RECOMMENDED BY THE MANUFACTURER. ONLY USE GEOTEXTILE SPECIFICALLY PRODUCED FOR SEDIMENT FENCING. THE USE OF SHADE CLOTH FOR THIS PURPOSE IS NOT SATISFACTORY.
- THE TRENCH. ENSURE ANY STAR PICKETS ARE FITTED WITH SAFETY CAPS.
- ENTRENCHED. DRIVE 1.5 METRE LONG STAR PICKETS INTO GROUND AT 2.5 METRE INTERVALS (MAX) AT THE DOWNSLOPE EDGE OF
- CUT A 150mm DEEP TRENCH ALONG THE UPSLOPE LINE OF THE FENCE FOR THE BOTTOM OF THE FABRIC TO BE 2
- CONSTRUCT SEDIMENT FENCES AS CLOSE AS POSSIBLE TO BEING PARALLEL TO THE CONTOURS OF THE SITE, BUT WITH SMALL RETURNS AS SHOWN IN THE DRAWING TO LIMIT THE CATCHMENT AREA OF ANY ONE SECTION. THE CATCHMENT AREA SHOULD BE SMALL ENOUGH TO LIMIT WATER FLOW IF CONCENTRATED AT ONE POINT TO 50 LITRES PER SECOND IN THE DESIGN STORM EVENT, USUALLY THE 10-YEAR EVENT.

### CONSTRUCTION NOTES:




1.5m STAR PICKETS

AT MAX. 2.5m CENTRES

### SD 6-8 MESH AND GRAVEL INLET FILTER

- SANDBAGS FILLED WITH GRAVEL CAN SUBSTITUTE FOR THE MESH OR GEOTEXTILE PROVIDING THEY ARE PLACED SO THAT THEY FIRMLY ABUT EACH OTHER AND SEDIMENT-LADEN WATERS CANNOT PASS BETWEEN.
- FORM A SEAL WITH THE KERB TO PREVENT SEDIMENT BYPASSING THE FILTER.
- PLACE THE FILTER AT THE OPENING LEAVING AT LEAST A 100mm SPACE BETWEEN IT AND THE KERB INLET. MAINTAIN THE OPENING WITH SPACER BLOCKS.
- FORM AN ELLIPTICAL CROSS-SECTION ABOUT 150mm HIGH X 400mm WIDE.
- FILL IT WITH 25mm TO 50mm GRAVEL.
- FABRICATE A SLEEVE MADE FROM GEOTEXTILE OR WIRE MESH LONGER THAN THE LENGTH OF THE INLET PIT AND


CONSTRUCTION NOTES: INSTALL FILTERS TO KERB INLETS ONLY AT SAG POINTS.

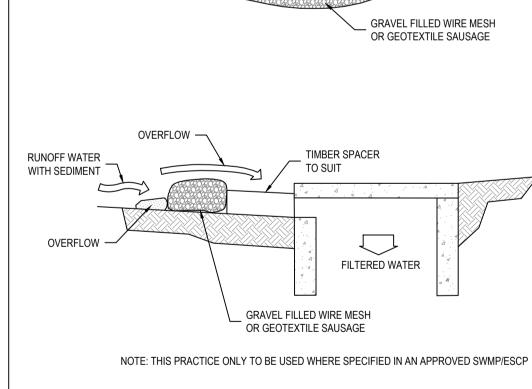

### STOCKPILES

NOTE

- CONSTRUCT EARTH BANKS (STANDARD DRAWING 5-5) ON THE UPSLOPE SIDE TO DIVERT WATER 5. AROUND STOCKPILES AND SEDIMENT FENCES (STANDARD DRAWING 6-8) 1 TO 2 METERS DOWNSLOPE.
- WHERE THEY ARE TO BE IN PLACE FOR MORE THAN 10 DAYS, STABILISE FOLLOWING THE APPROVED ESCP OR SWMP TO REDUCE THE C-FACTOR TO LESS THAN 0.10.
- WHERE THERE IS SUFFICIENT AREA, TOPSOIL STOCKPILES SHALL BE LESS THAN 2 METERS IN HEIGHT.
- CONSTRUCT ON THE CONTOUR AS LOW, FLAT, ELONGATED MOUNDS.
- PLACE STOCKPILES MORE THAN 2 (PREFERABLY 5) METERS FROM EXISTING VEGETATION, CONCENTRATED WATER FLOW, ROADS AND HAZARD AREAS.
- CONSTRUCTION NOTES:

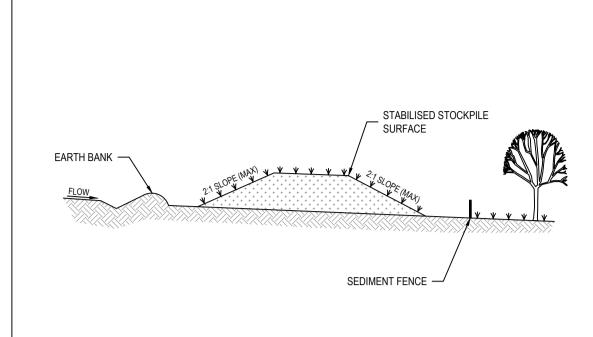

ALL EROSION & SEDIMENTATION CONTROL (ESC) PLAN DETAILS SHOWN ARE FROM "MANAGING URBAN STORMWATER - SOILS AND CONSTRUCTION", LANDCOM, 2004. DETAILS, ALTHOUGH NOT SPECIFICALLY IDENTIFIED FOR USE ON THE ESC PLAN (SHEET C03.01), ARE PROVIDED IN THE EVENT ADDITIONAL CONTROLS ARE REQUIRED TO MINIMISE ON-SITE EROSION DURING THE COURSE OF CONSTRUCTION. IF AN ESC DETAIL IS NOT SHOWN, CONTRACTOR SHALL REFER TO THE ABOVE REFERENCED GUIDE.

### **REPLACING TOPSOIL**

SD 4-1

SELF-SUPPORTING

GEOTEXTILE

CONSTRUCTION NOTES:

SUBSOIL SERRATED

ALONG CONTOUR BY

GRADER OR RIPPER

- EXCEEDS 4(H):1(V) AND TO AT LEAST 75mm ON LOWER GRADIENTS.
- RIP TO A DEPTH OF 300mm IF COMPACTED LAYERS OCCUR. WHERE POSSIBLE, REPLACE TOPSOIL TO A DEPTH OF 40 TO 60mm ON LANDS WHERE THE SLOPE

KERB SIDE INLET

TIMBER SPACER

TO SUIT


SCARIFY THE GROUND SURFACE ALONG THE LINE OF THE CONTOUR TO A DEPTH OF 50mm TO 100mm TO BREAK UP ANY HARDSETTING SURFACES AND TO PROVIDE A GOOD BOND BETWEEN THE RESPREAD MATERIAL AND SUBSOIL.


OPSOIL DEPTH


- ADD SOIL AMELIORANTS AS REQUIRED BY THE ESCP OR SWMP.



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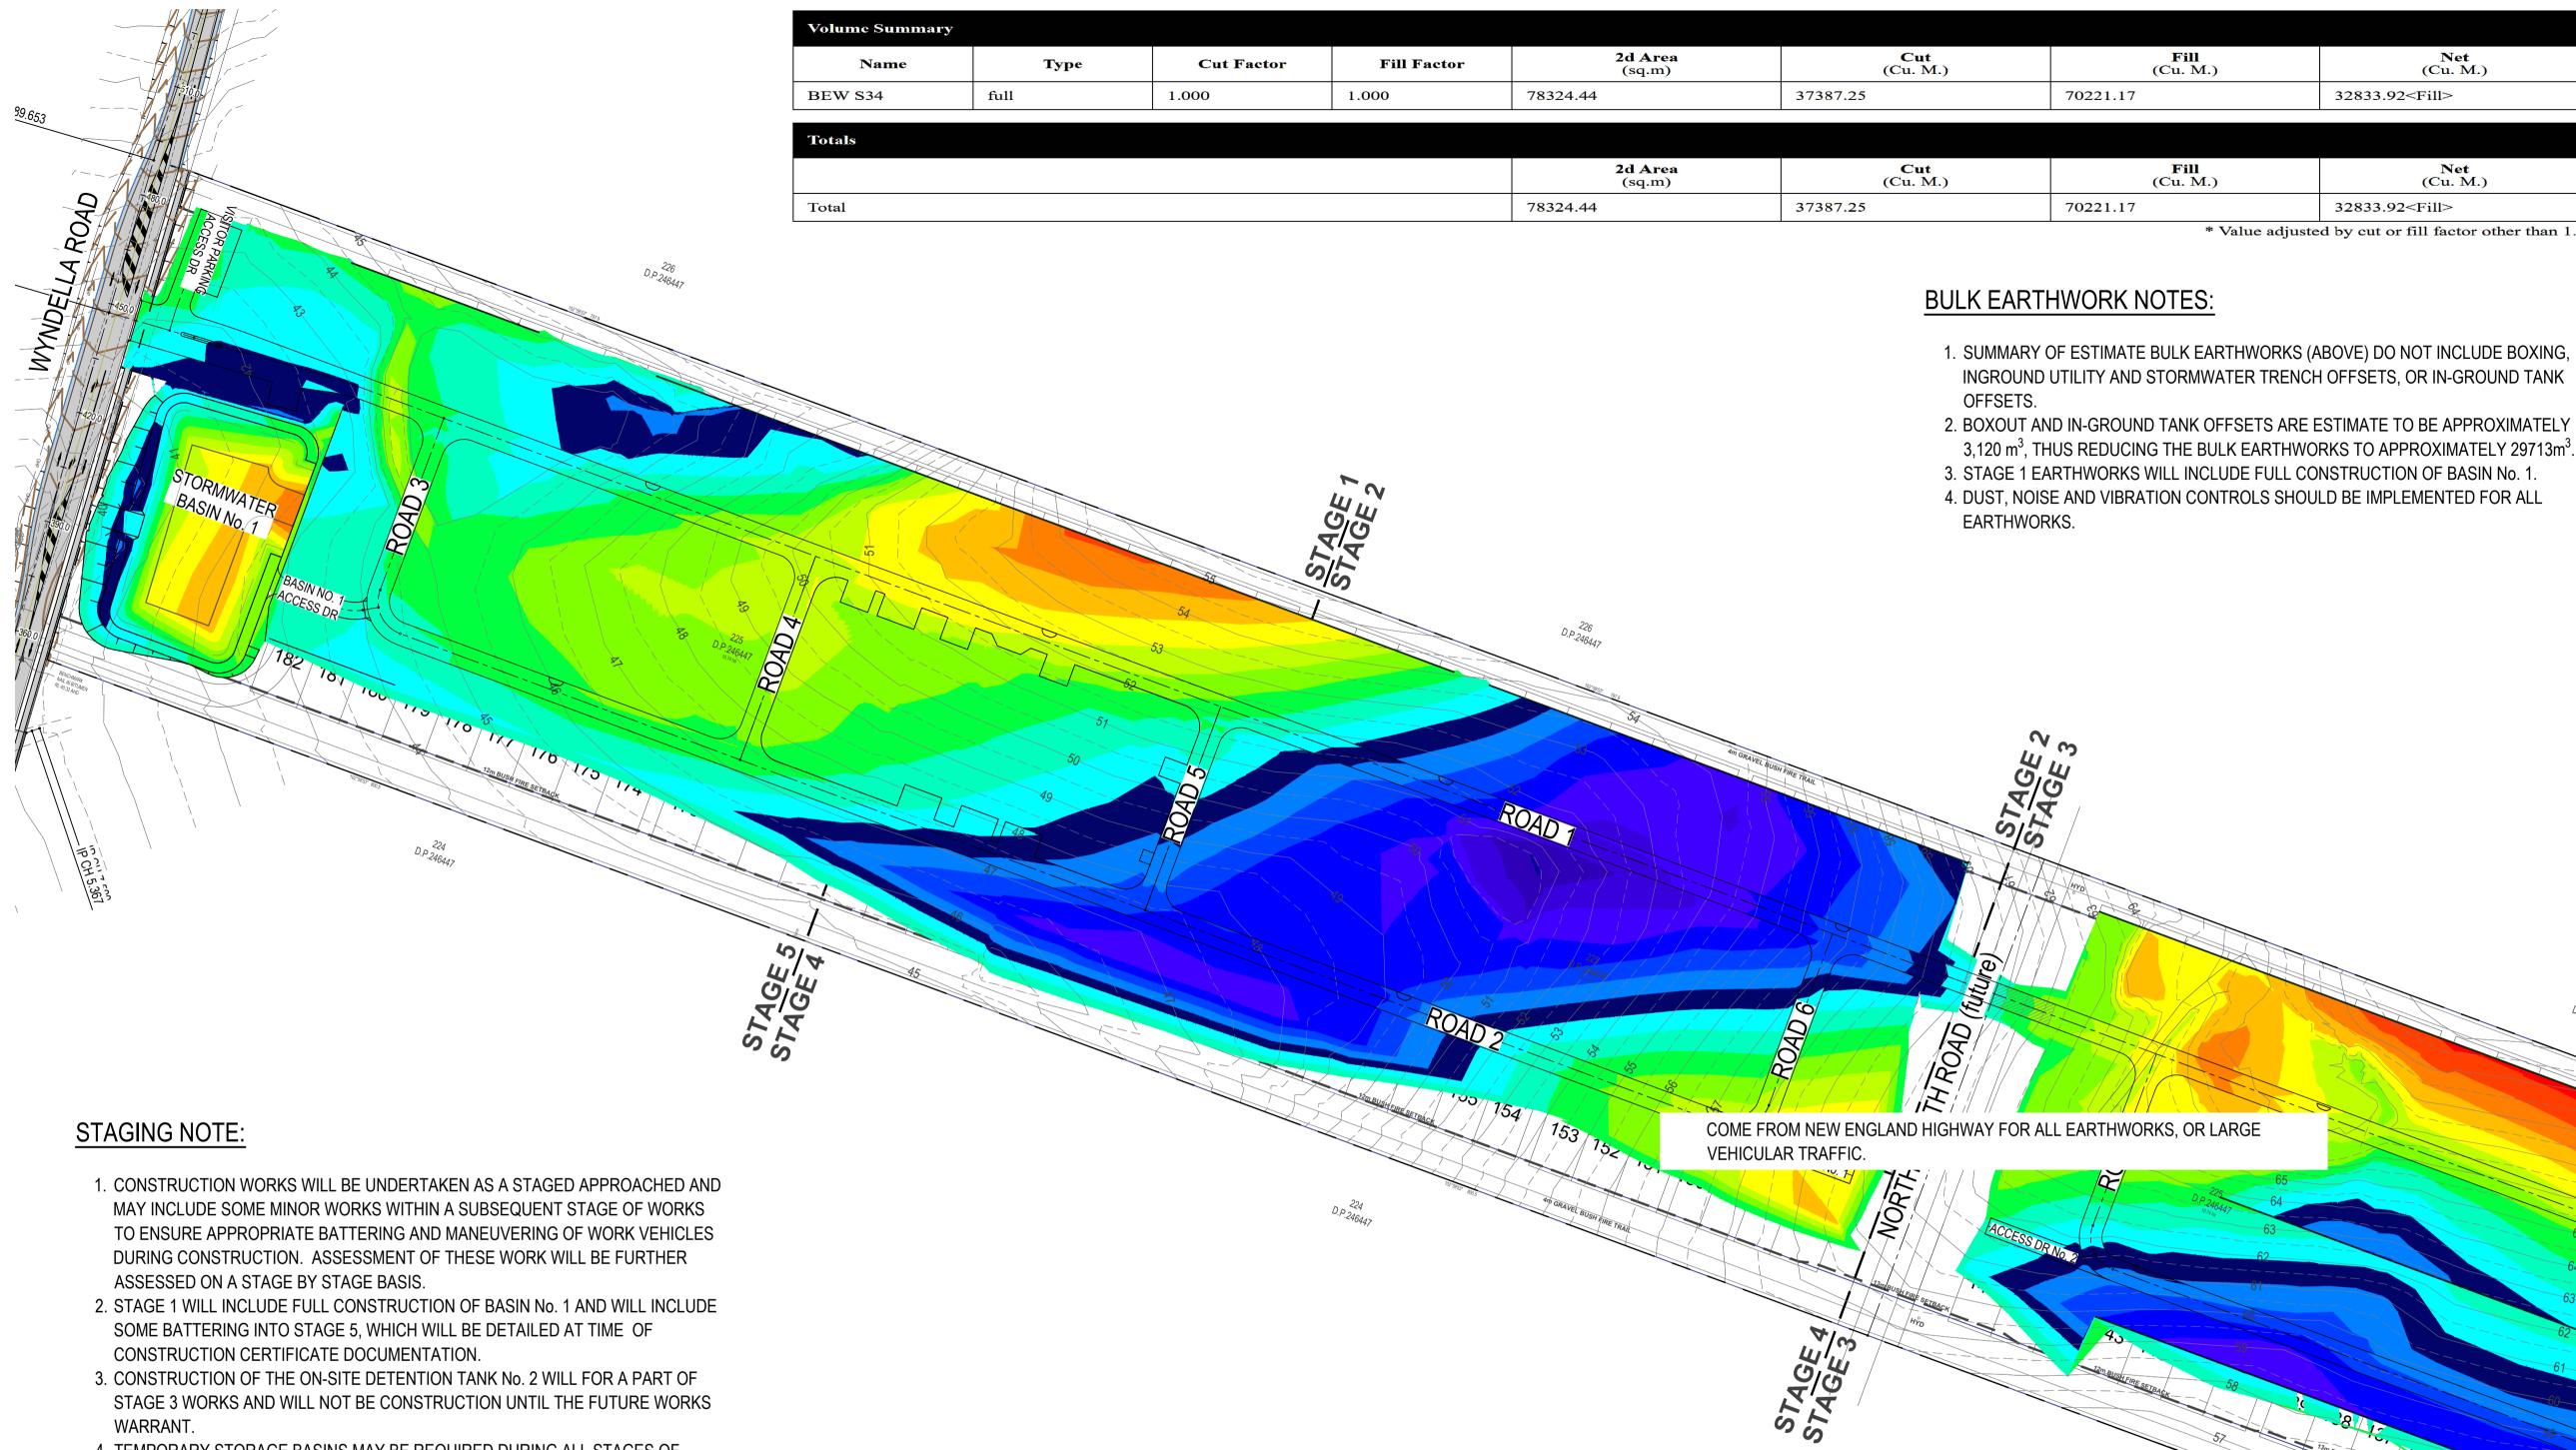


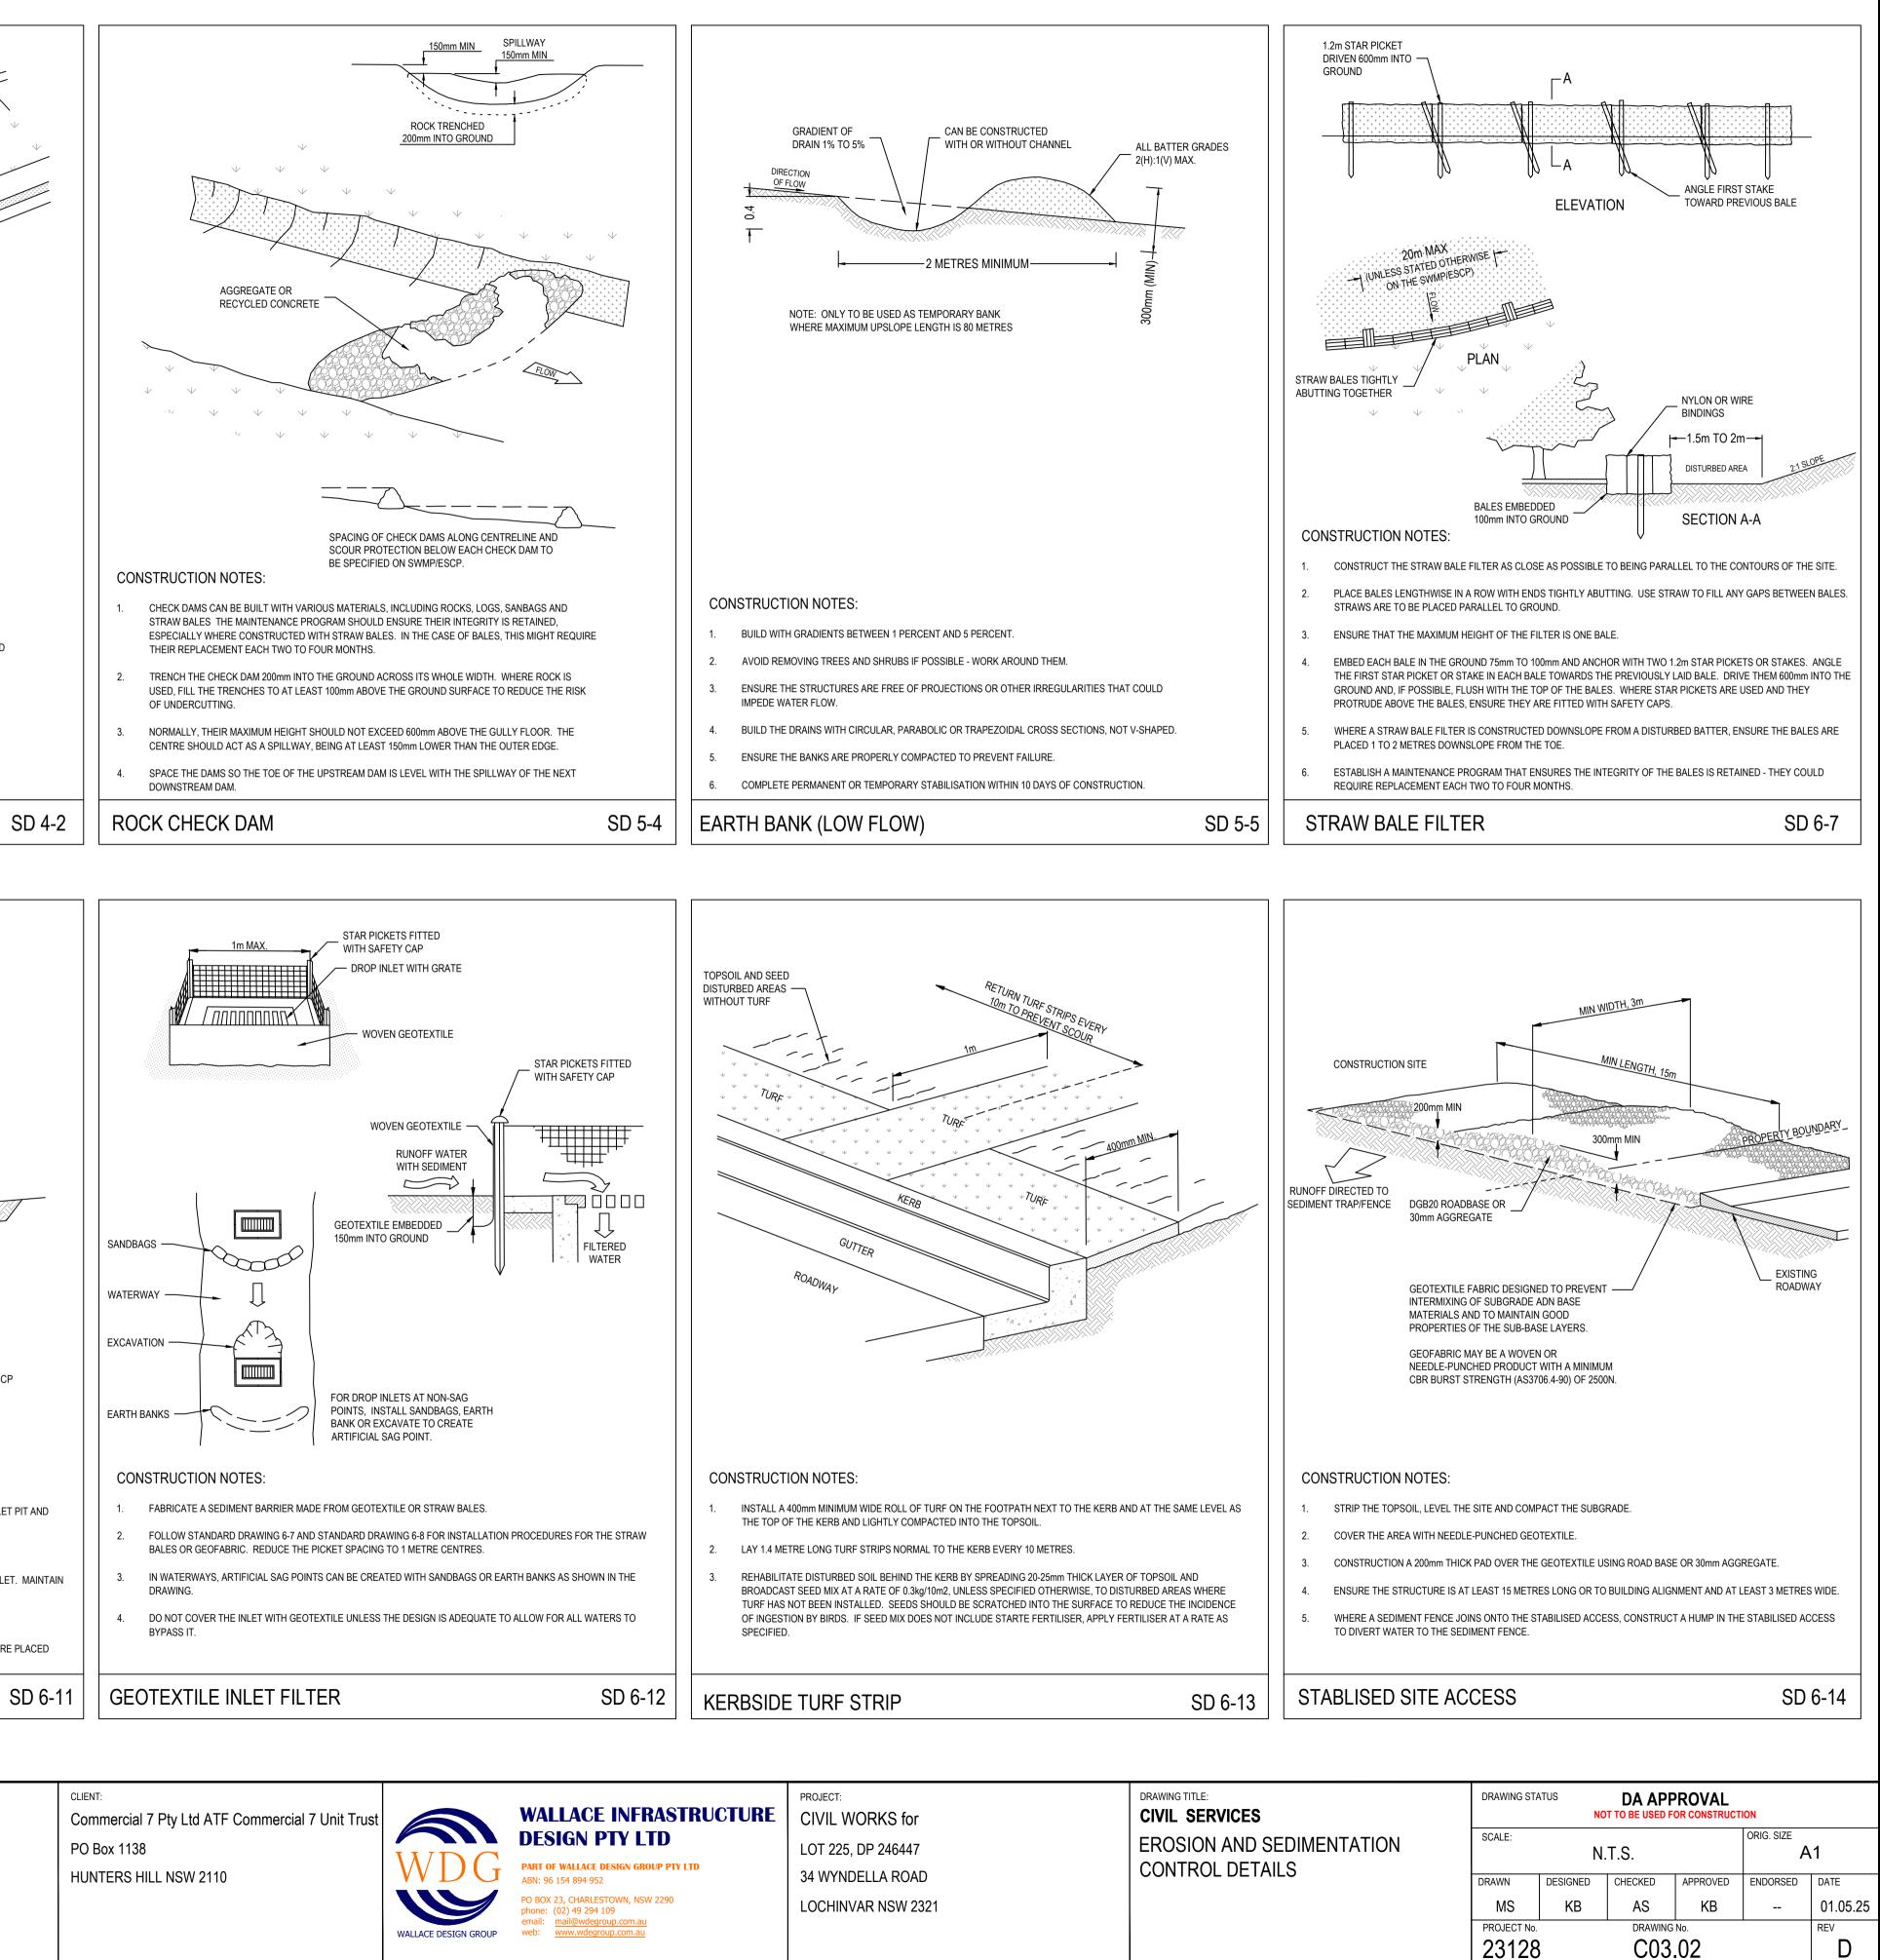
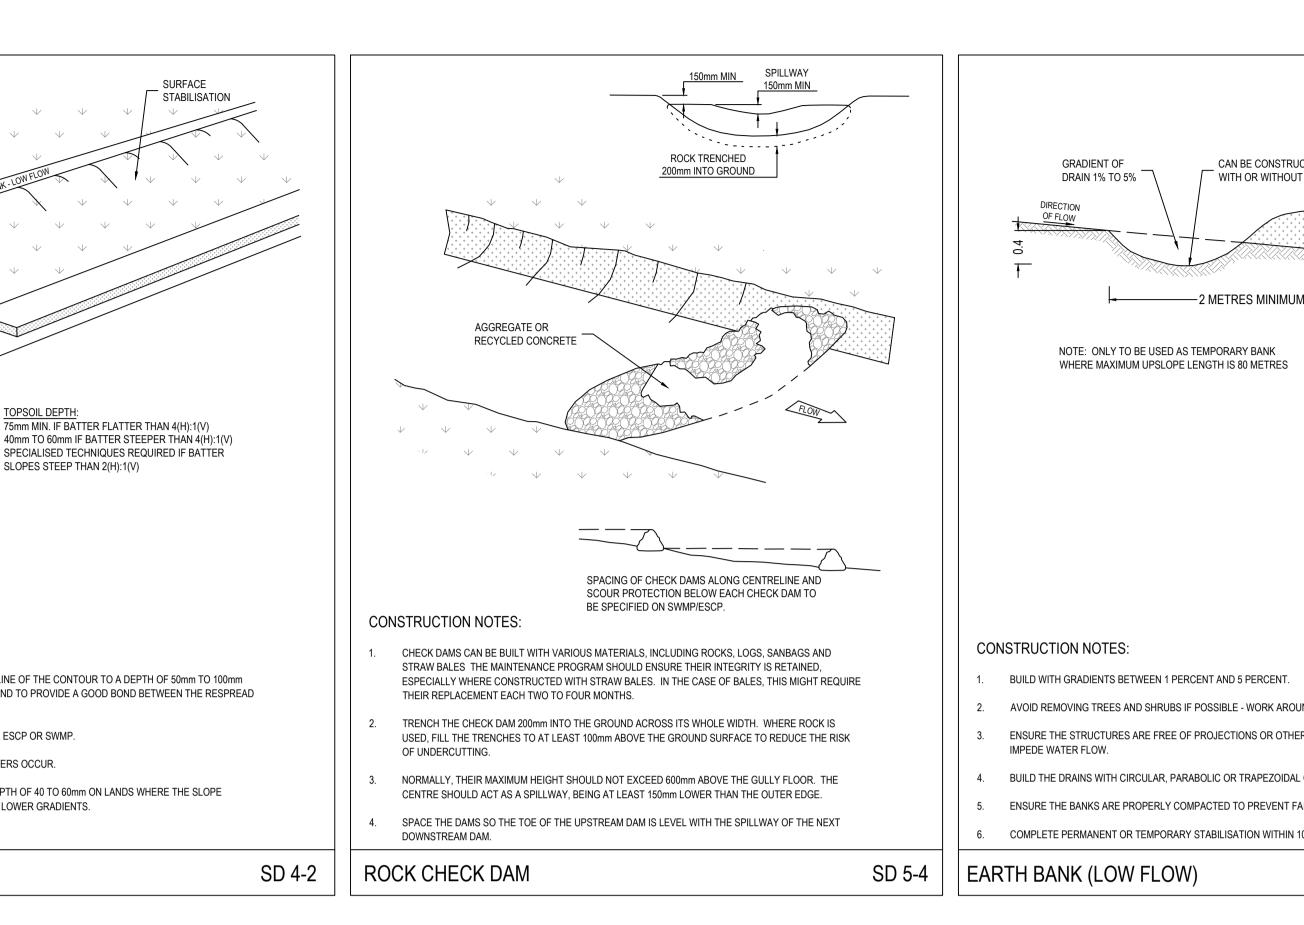
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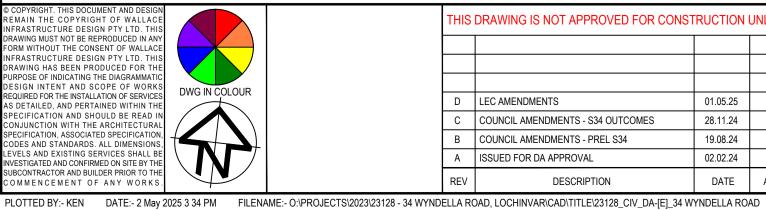
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- WARRANT.
- 4. TEMPORARY STORAGE BASINS MAY BE REQUIRED DURING ALL STAGES OF WORKS. THESE BASINS WILL BE FURTHER DETAILED DURIING THE CONSTRUCTION CERTIFICATE STAGE OF WORKS FOR ALL STAGES.
- 5. TRAFFIC AND PEDESTRIAN MANAGEMENT DURING BEW SHALL BE PROVIDED IN ALL INSTANCES.
- 6. A DETAILED CONSTRUCTION AND TRAFFIC MANAGEMENT PLAN WILL BE PREPARED AS PART OF EACH STAGE OF WORKS FOR EACH STAGE OF WORKS.
- 7. ALL CONSTRUCTION ACTIVITY IS LIMITED TO INGRESS AT THE MAIN ENTRANCE AND EGRESS AT THE EXISTING FARM ACCESS DRIVE WHICH WILL BE ENLARGED TO ALLOW APPROPRIATE TURNING MOVEMENTS. ACCESS TO THE LIMITED MUST
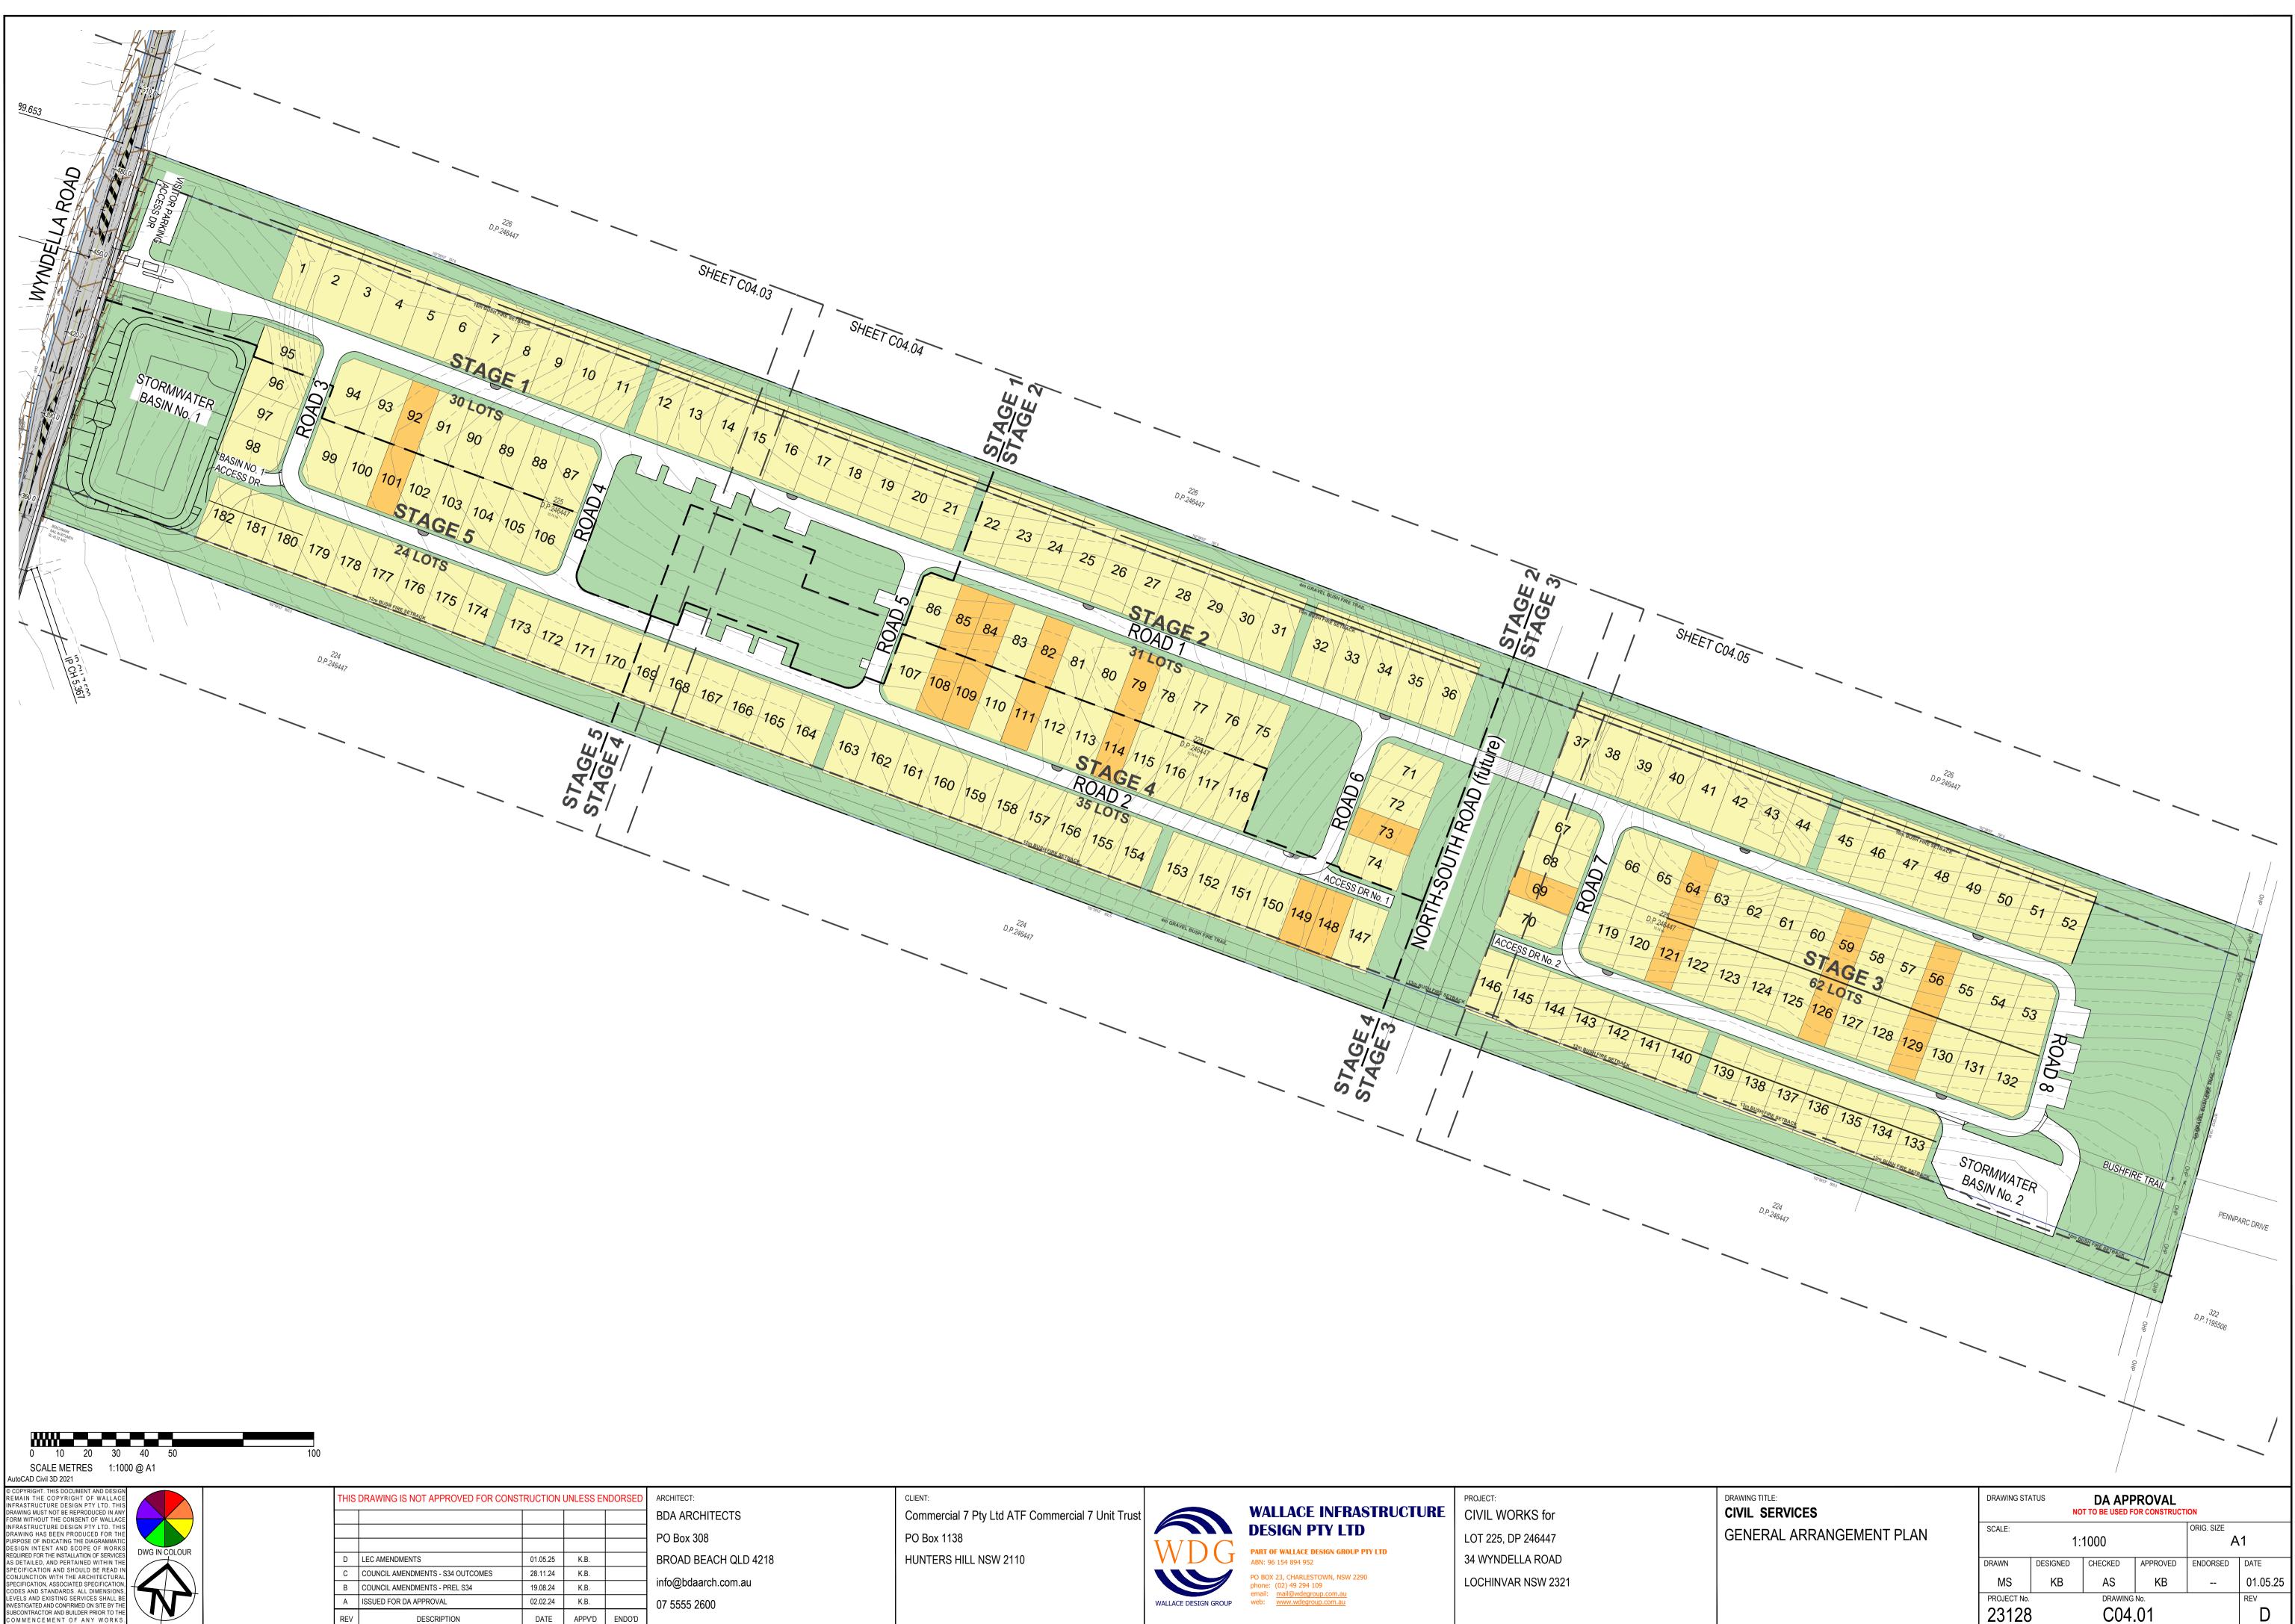
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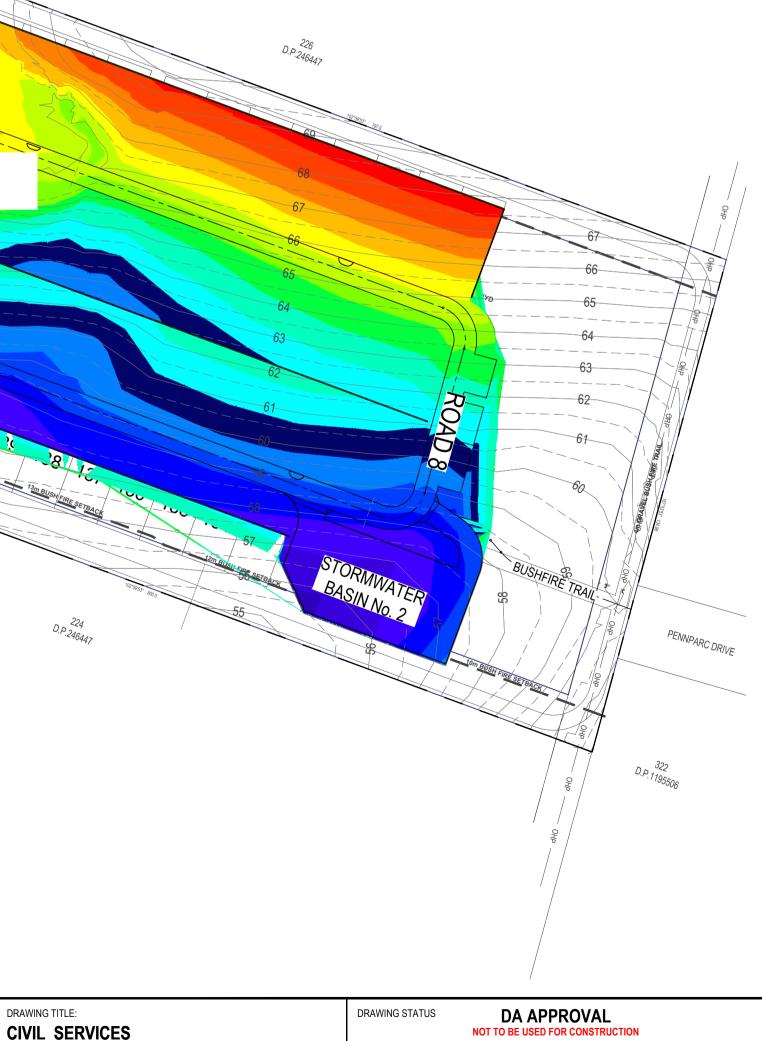
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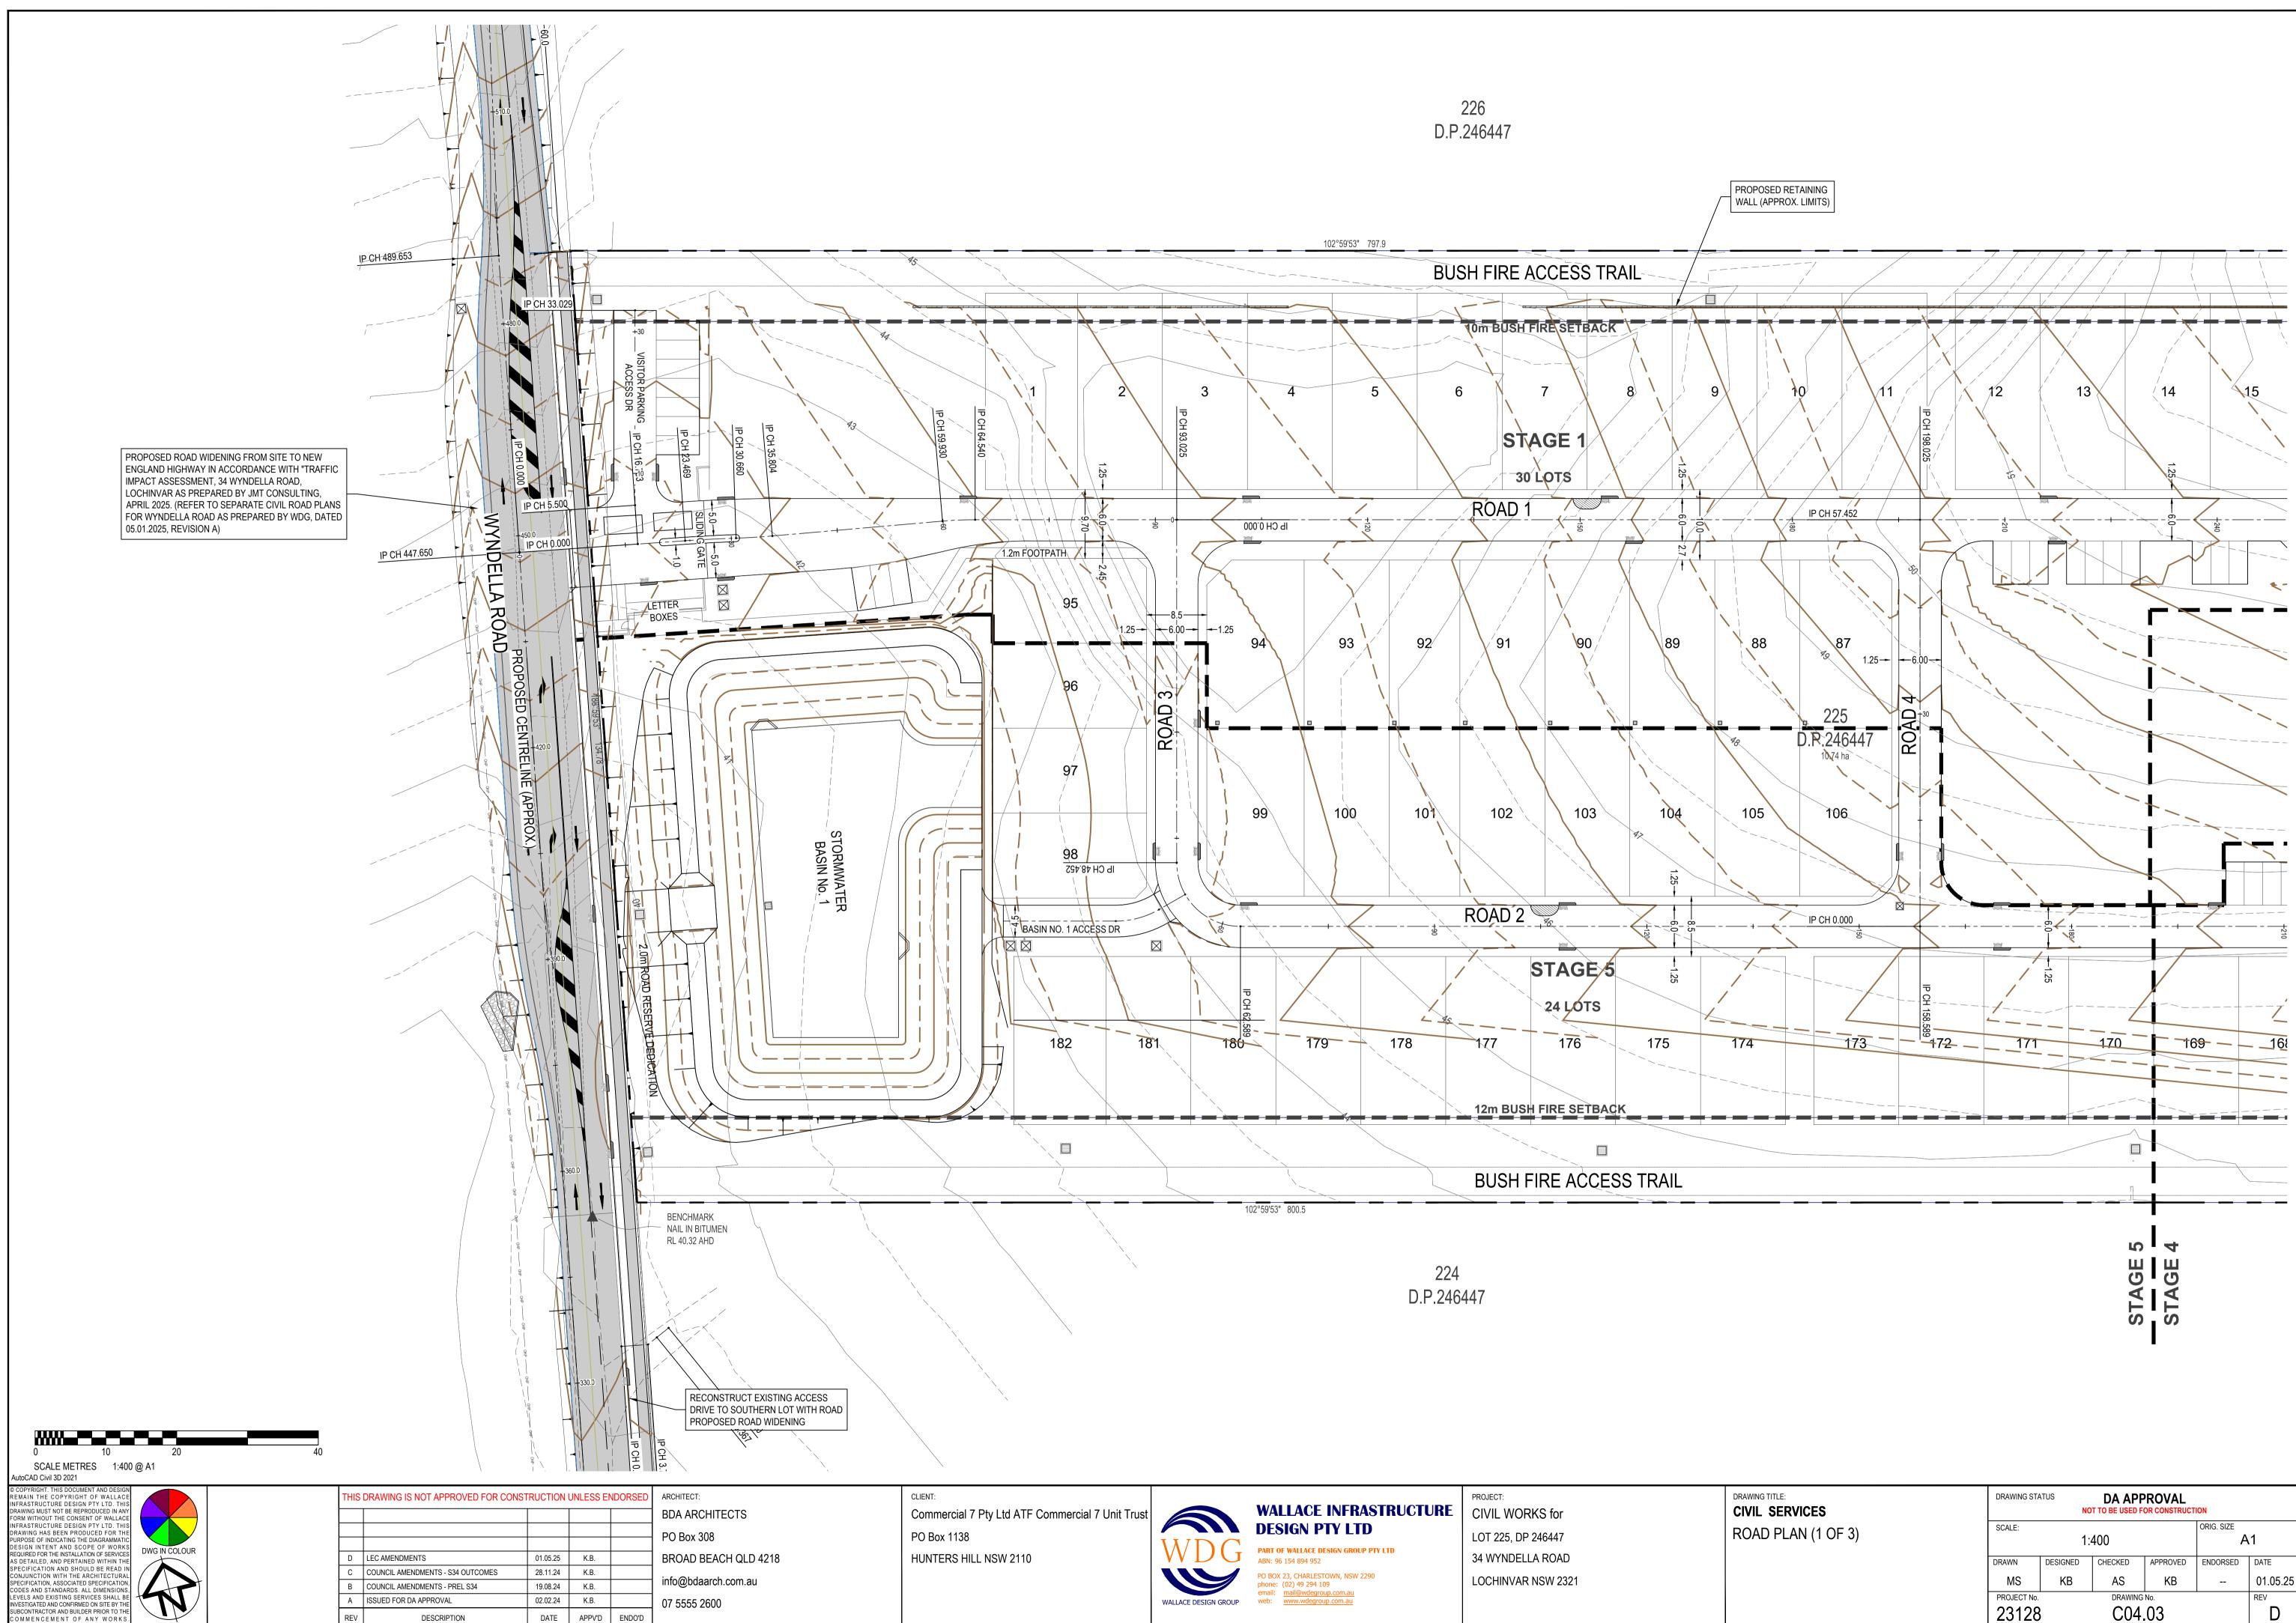
### CUT/FILL TABLE BY ELEVATION

Number	Minimum Elevation	Maximum Elevation	Color
1	-4.000	-3.500	
2	-3.500	-3.000	
3	-3.000	-2.500	
4	-2.500	-2.000	
5	-2.000	-1.500	
6	-1.500	-1.000	
7	-1.000	-0.500	
8	-0.500	0.000	
9	0.000	0.500	
10	0.500	1.000	
11	1.000	1.500	
12	1.500	2.000	
13	2.000	2.500	
14	2.500	3.000	
15	3.000	3.500	
16	3.500	4.000	
17	4.000	4.500	
18	4.500	5.000	



### BULK EARTHWORKS PLAN

	NOT TO BE USED FOR CONSTRUCTION									
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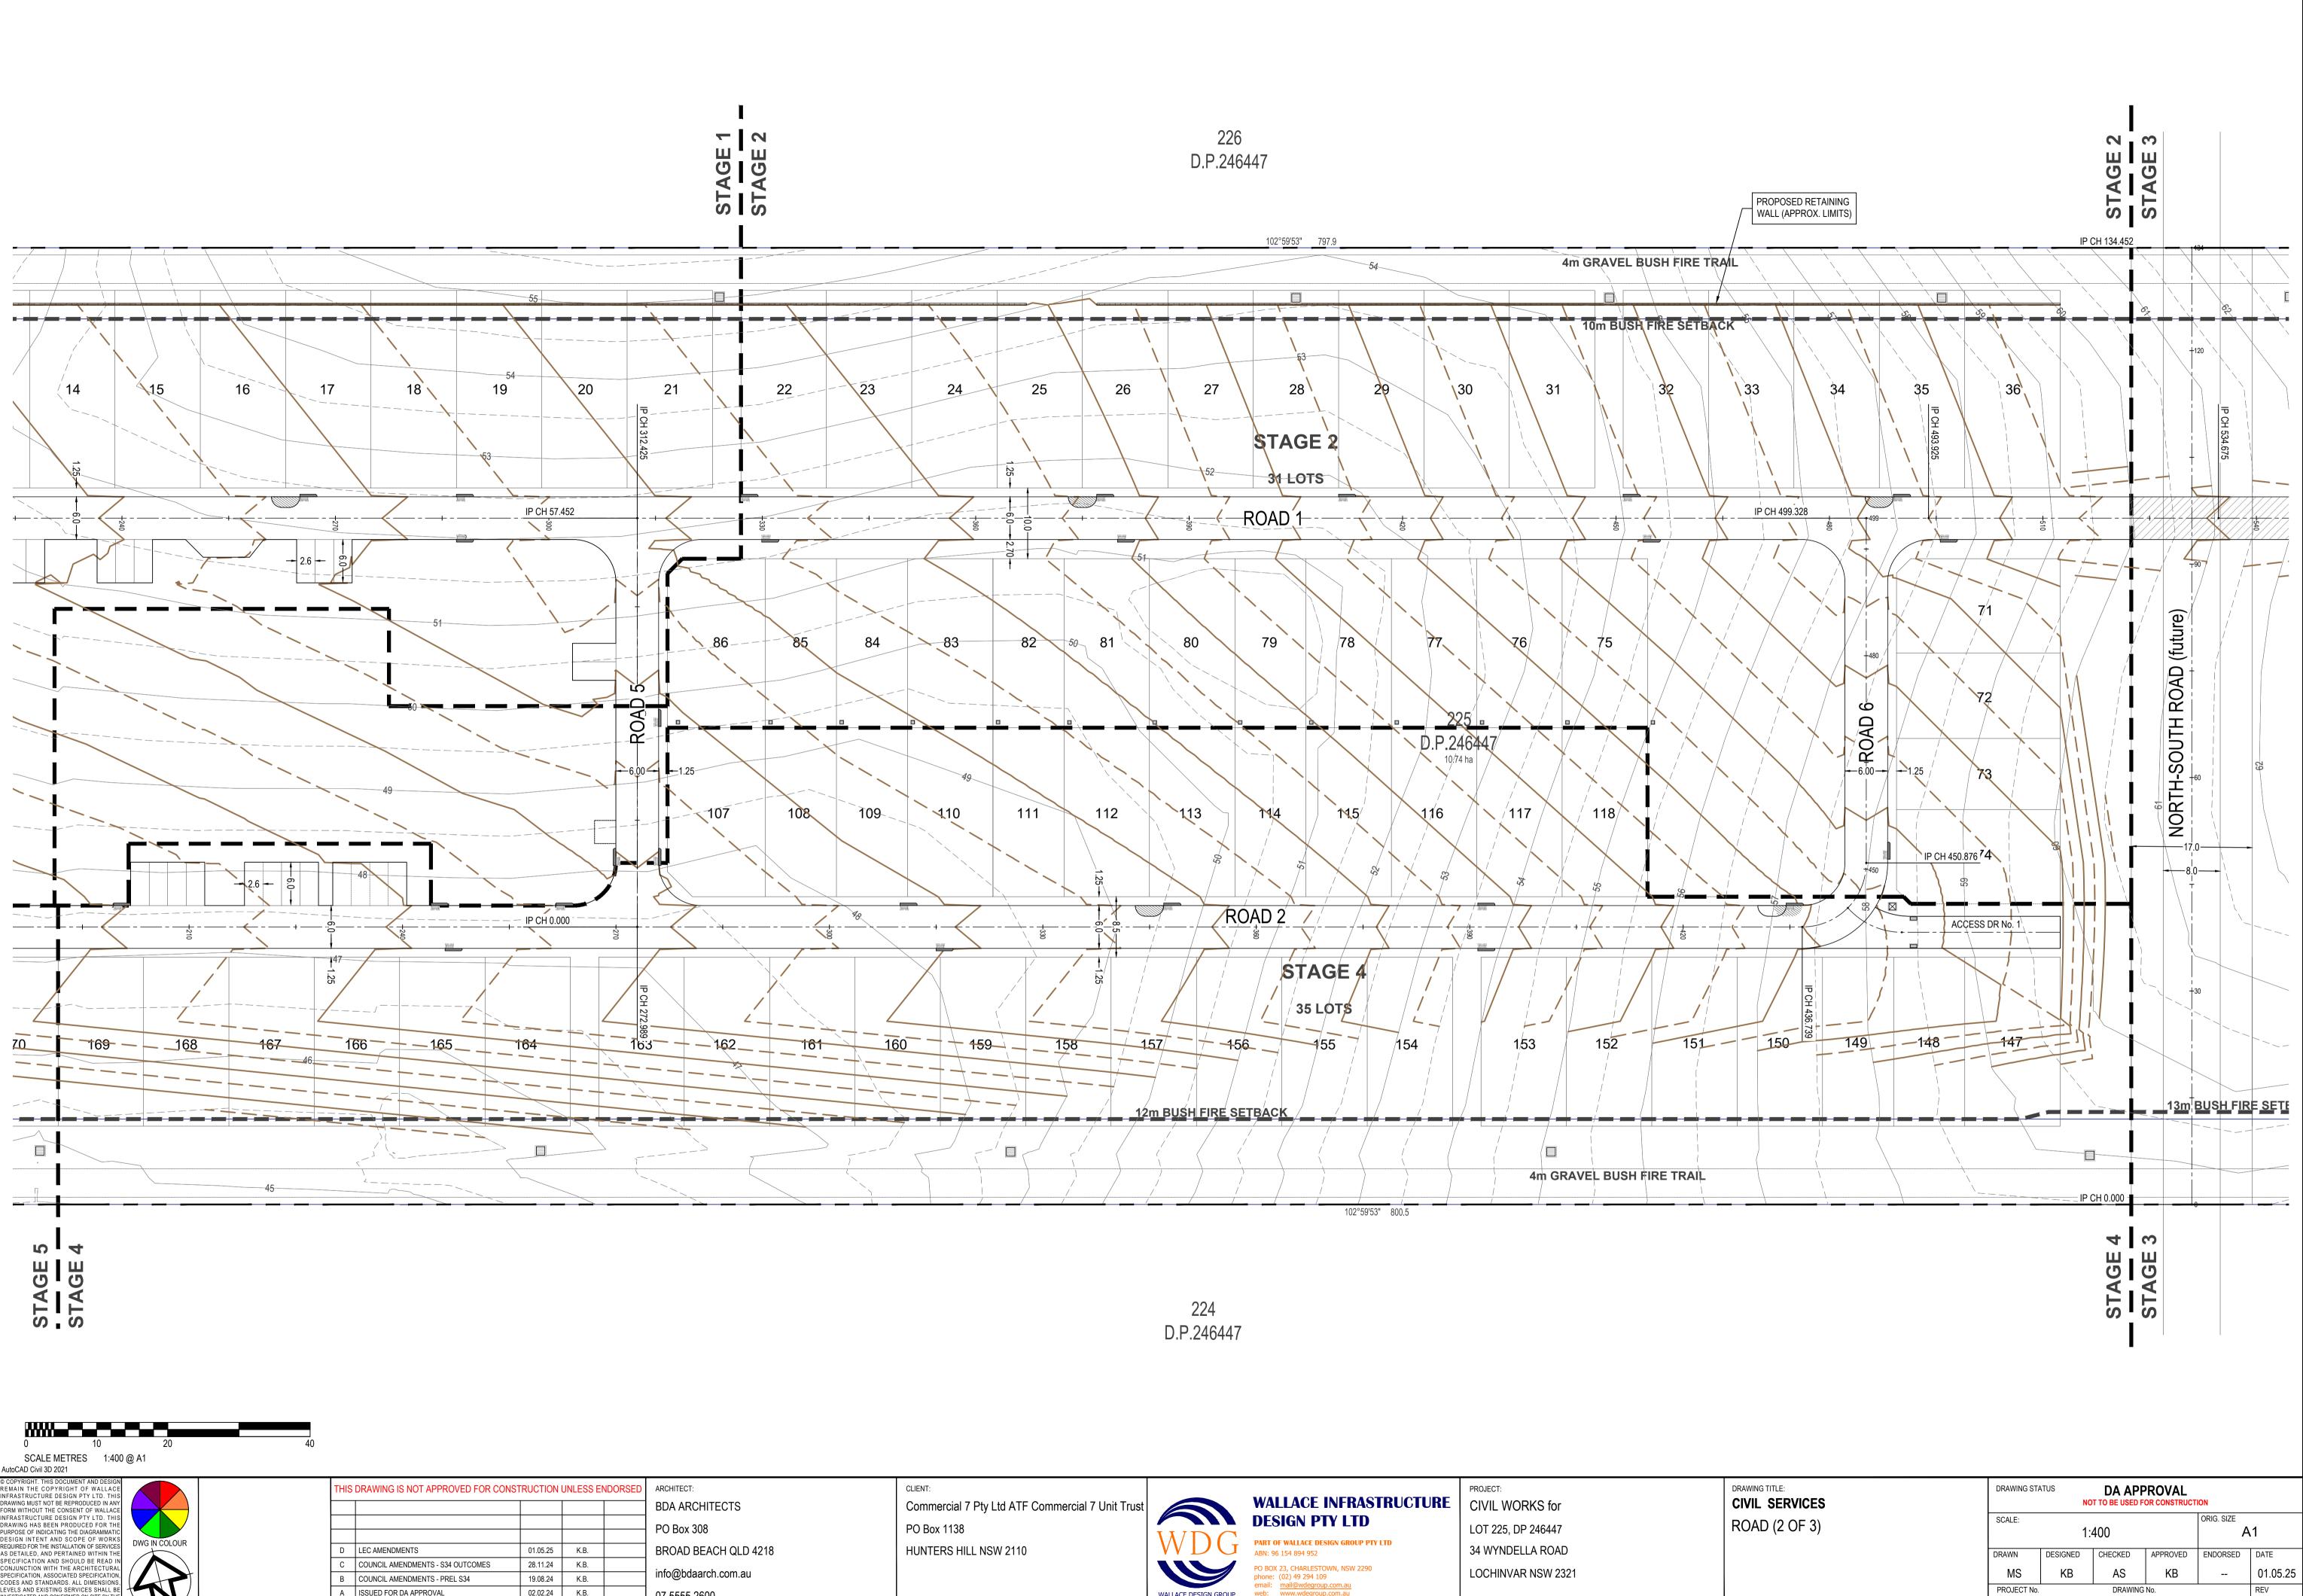



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OMMENCEMENT OF ANY WORKS.

DESCRIPTION

DATE APPV'D ENDO'D



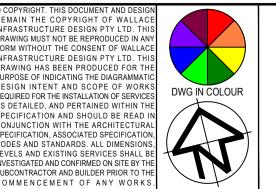

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LEVELS AND EXISTING SERVICES SHALL BE INVESTIGATED AND CONFIRMED ON SITE BY THE			А	ISSUED FOR DA APPROVAL	02.02.24	K.B.		07 5555 2
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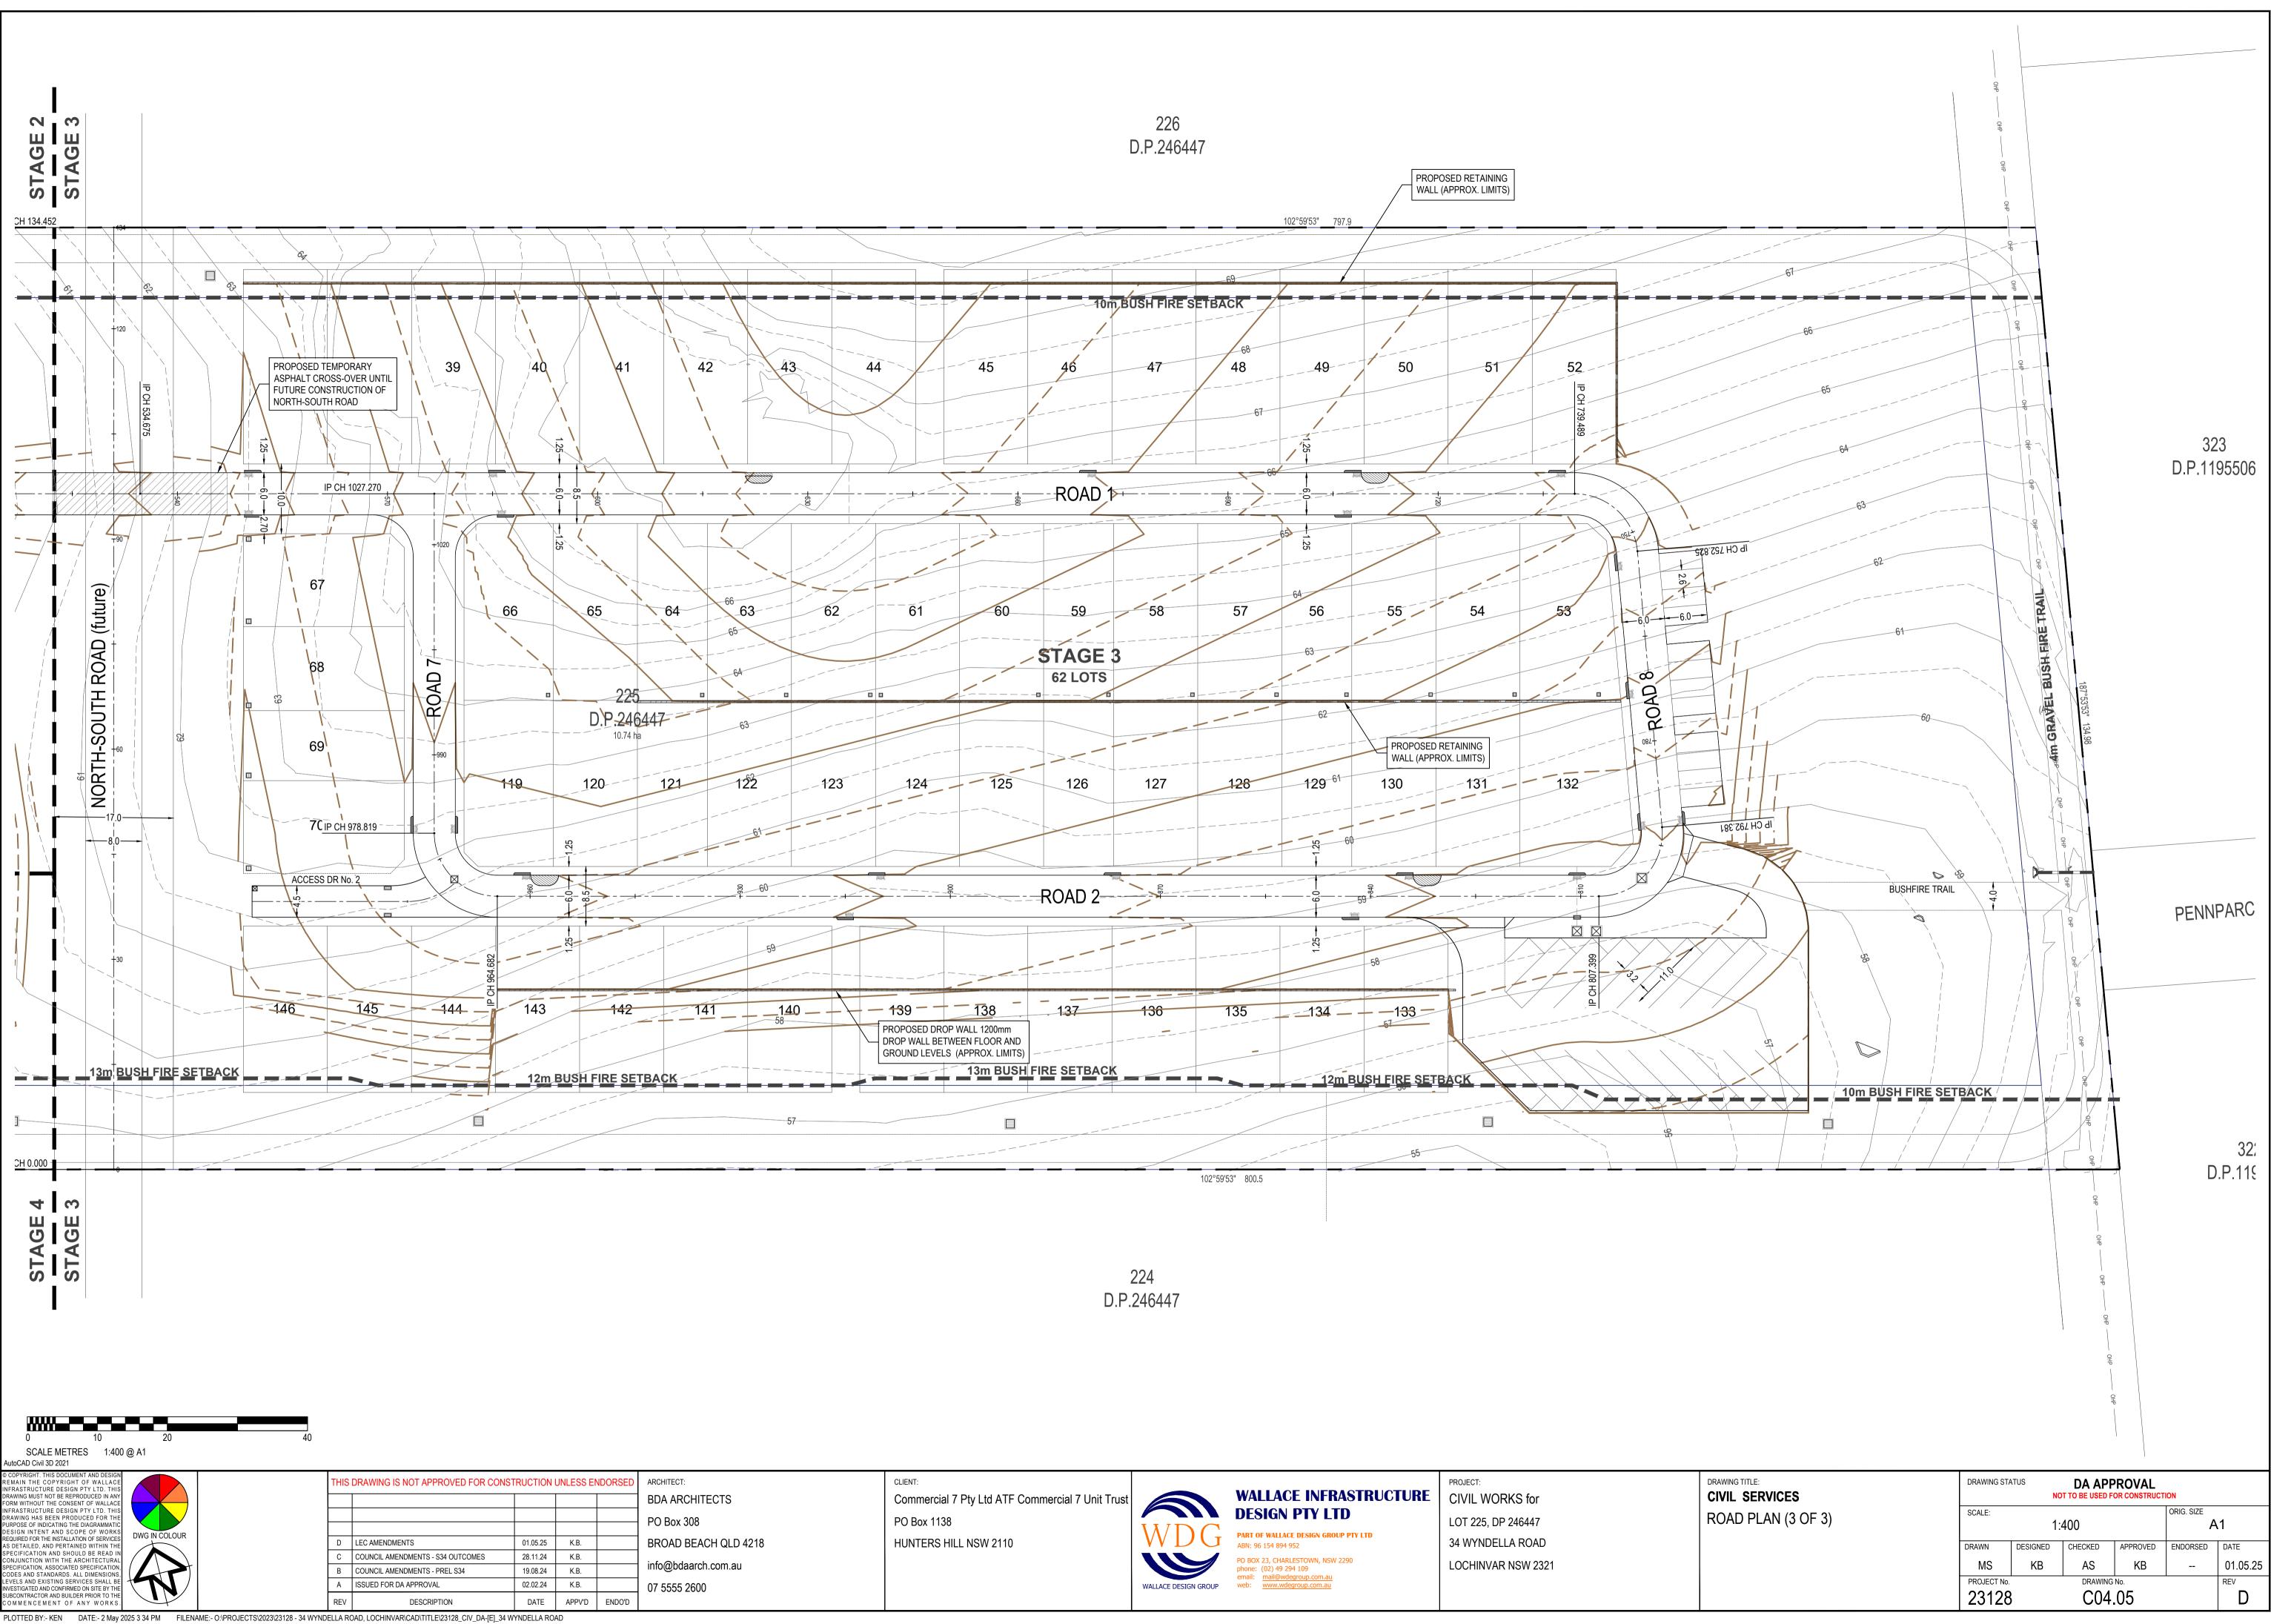
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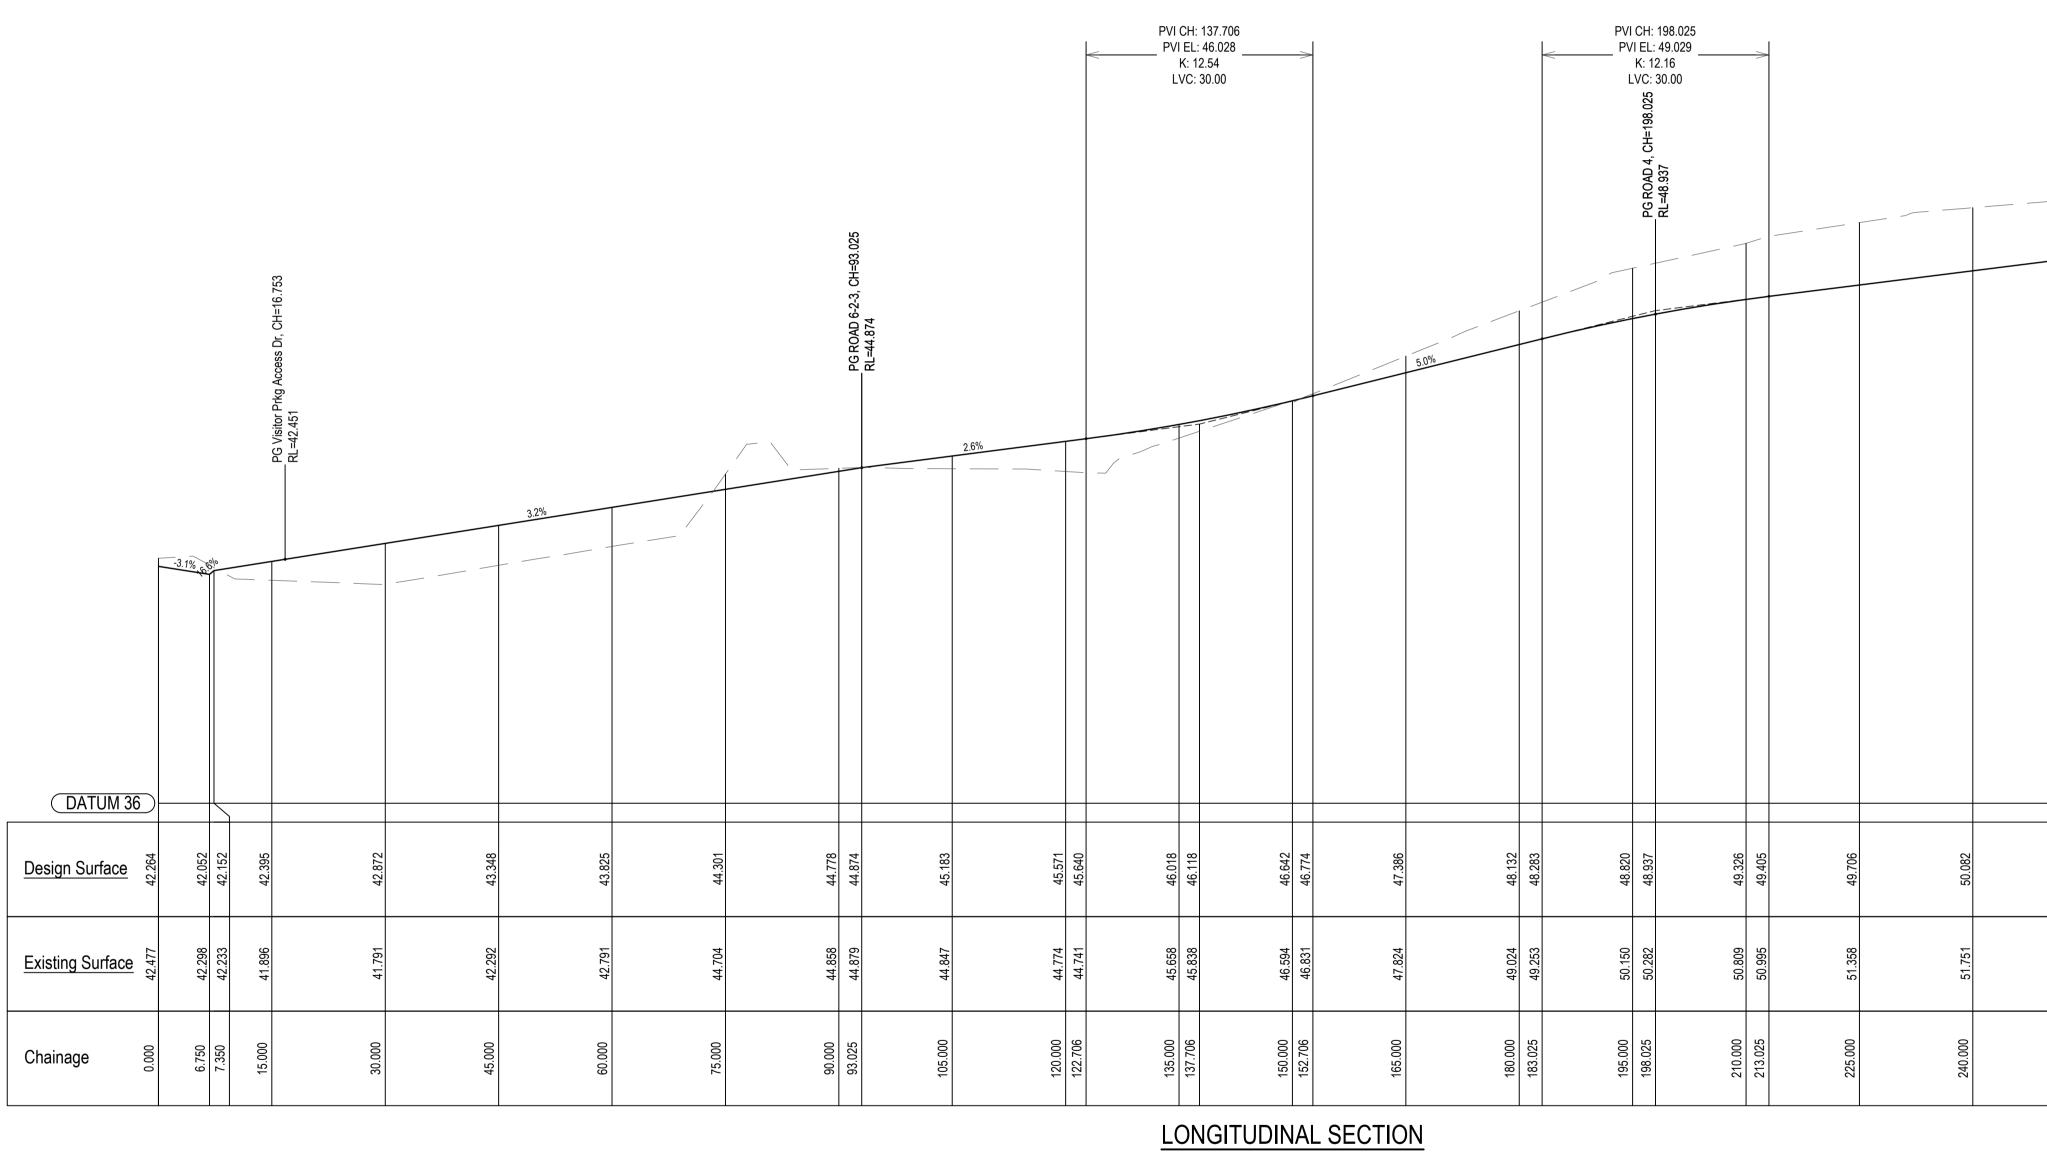
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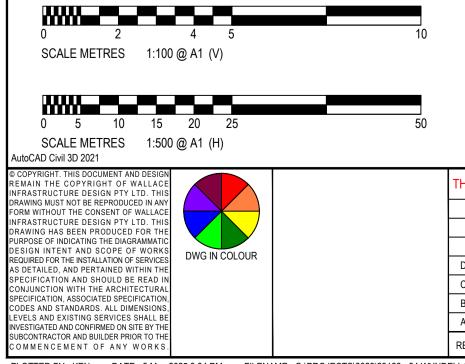
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INFRASTRUCTURE DESIGN PTY LTD. THIS DRAWING HAS BEEN PRODUCED FOR THE PURPOSE OF INDICATING THE DIAGRAMMATIC DESIGN INTENT AND SCOPE OF WORKS								PO Box 308
REQUIRED FOR THE INSTALLATION OF SERVICES AS DETAILED, AND PERTAINED WITHIN THE	DWG IN COLOUR	D	DI	LEC AMENDMENTS	01.05.25	K.B.		BROAD BEAC
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SPECIFICATION, ASSOCIATED SPECIFICATION, CODES AND STANDARDS. ALL DIMENSIONS,		В	В	COUNCIL AMENDMENTS - PREL S34	19.08.24	K.B.		info@bdaarch.
LEVELS AND EXISTING SERVICES SHALL BE INVESTIGATED AND CONFIRMED ON SITE BY THE		А	A I	ISSUED FOR DA APPROVAL	02.02.24	K.B.		07 5555 2600
SUBCONTRACTOR AND BUILDER PRIOR TO THE COMMENCEMENT OF ANY WORKS.		RE	EV	DESCRIPTION	DATE	APPV'D	ENDO'D	
PLOTTED BY:- KEN DATE:- 2 May 2025 3 34 PM FILENAME:- O:\PROJECTS\2023\23128 - 34 WYNDELLA ROAD, LOCHINVAR\CAD\TITLE\23128_CIV_DA-[E]_34 WYNDELLA ROAD								

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ROAD 1-8-2-7





WALLACE INFRASTRUCTURE CIVIL WORKS for LOT 225 DP 246447

PROJECT: LOT 225, DP 246447 34 WYNDELLA ROAD LOCHINVAR NSW 2321

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DRAWING TITLE: CIVIL SERVICES	DRAWING STATUS <b>DA APPROVAL</b> NOT TO BE USED FOR CONSTRUCTION					
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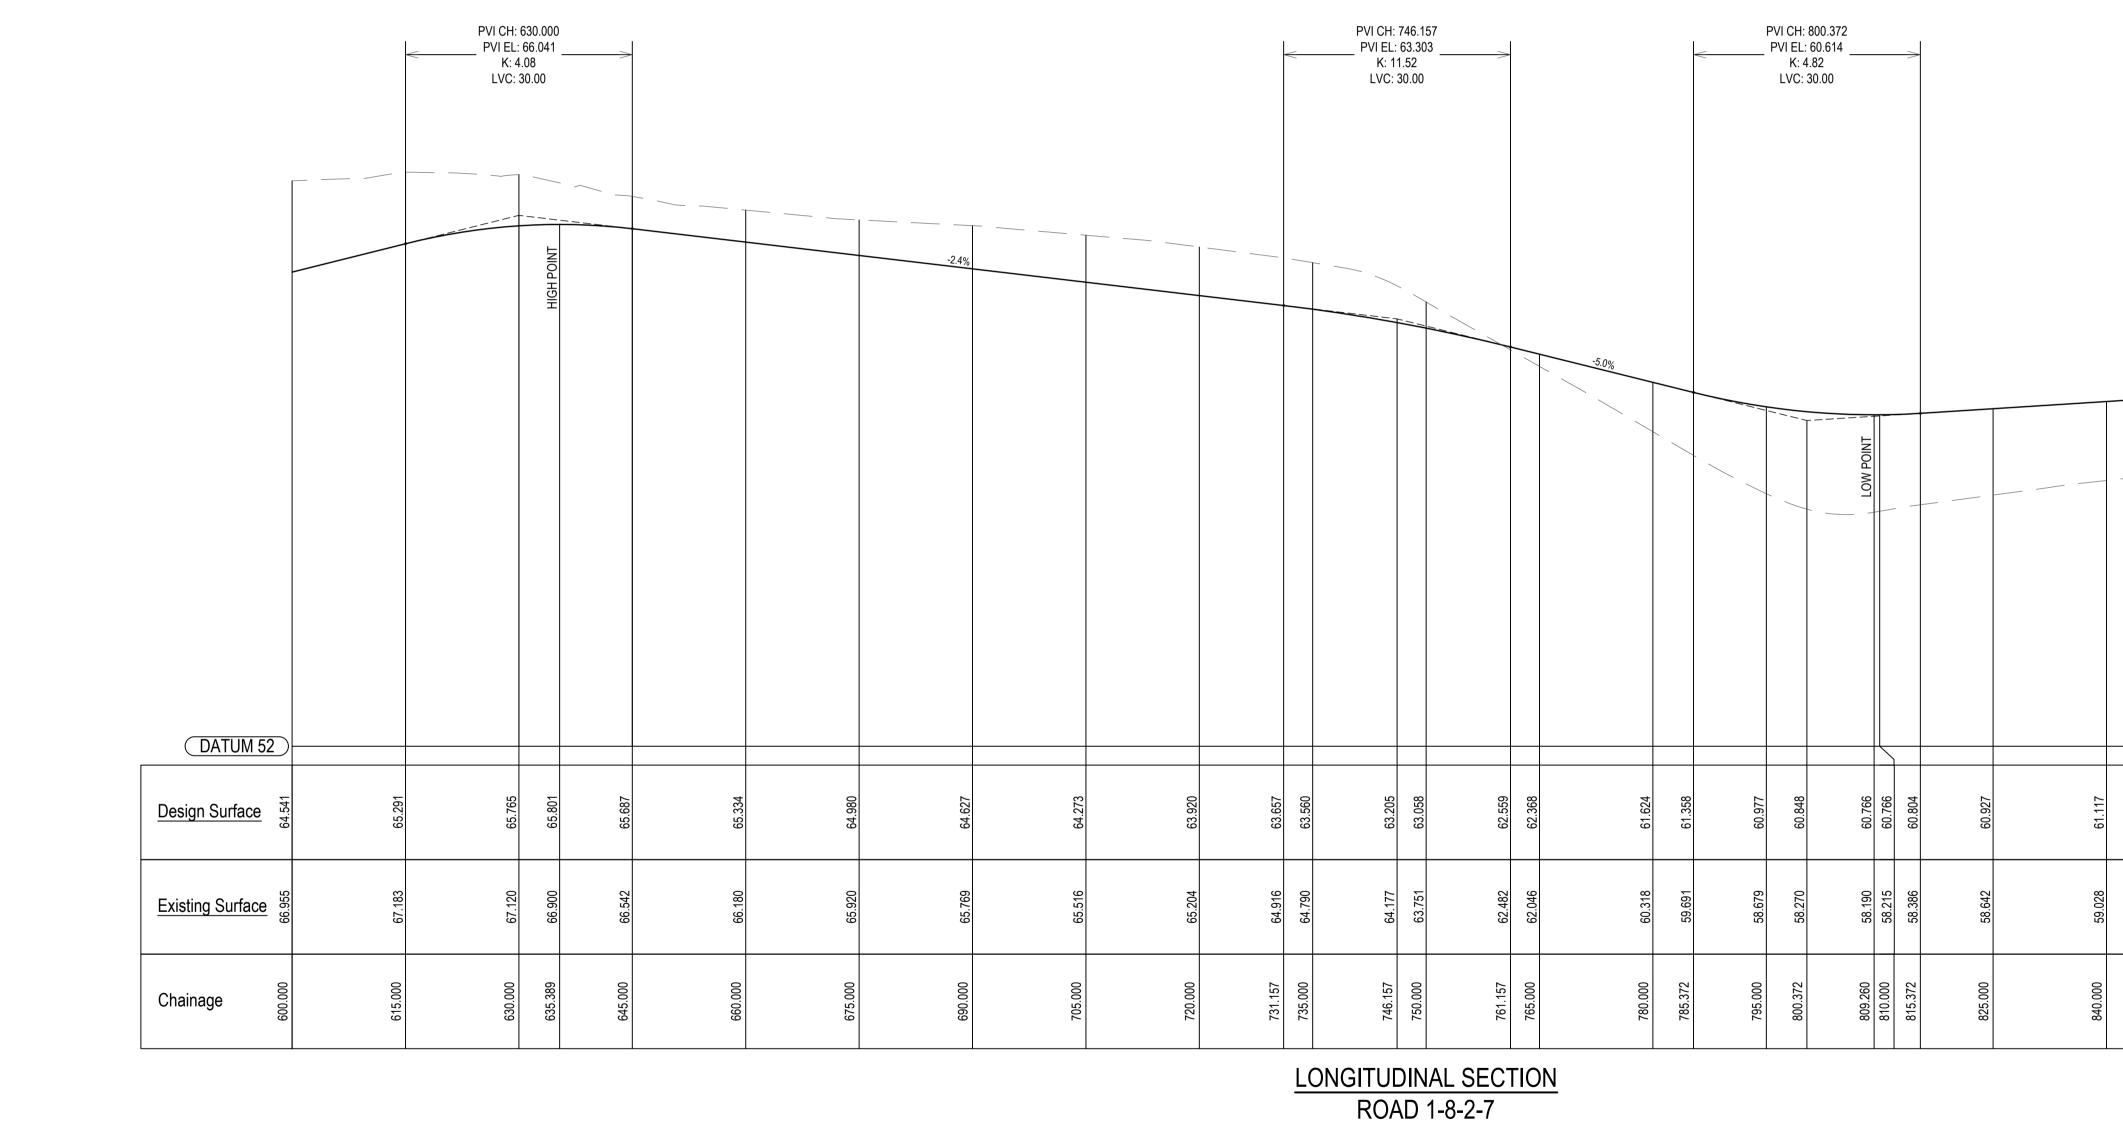
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DRAWING HAS BEEN PRODUCED FOR THE PURPOSE OF INDICATING THE DIAGRAMMATIC DESIGN INTENT AND SCOPE OF WORKS								PO Box 3		
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LEVELS AND EXISTING SERVICES SHALL BE INVESTIGATED AND CONFIRMED ON SITE BY THE			А	ISSUED FOR DA APPROVAL	02.02.24	K.B.		07 5555 2		
SUBCONTRACTOR AND BUILDER PRIOR TO THE COMMENCEMENT OF ANY WORKS.			REV	DESCRIPTION	DATE	APPV'D	ENDO'D			
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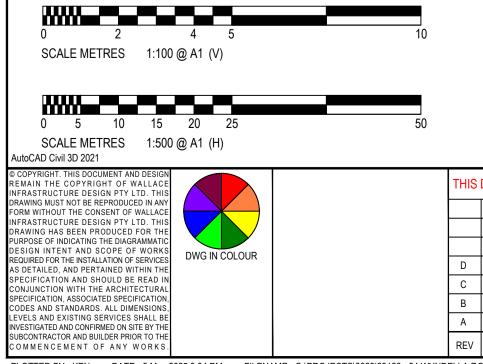
RCHITECTS 308 D BEACH QLD 4218 daarch.com.au 2600

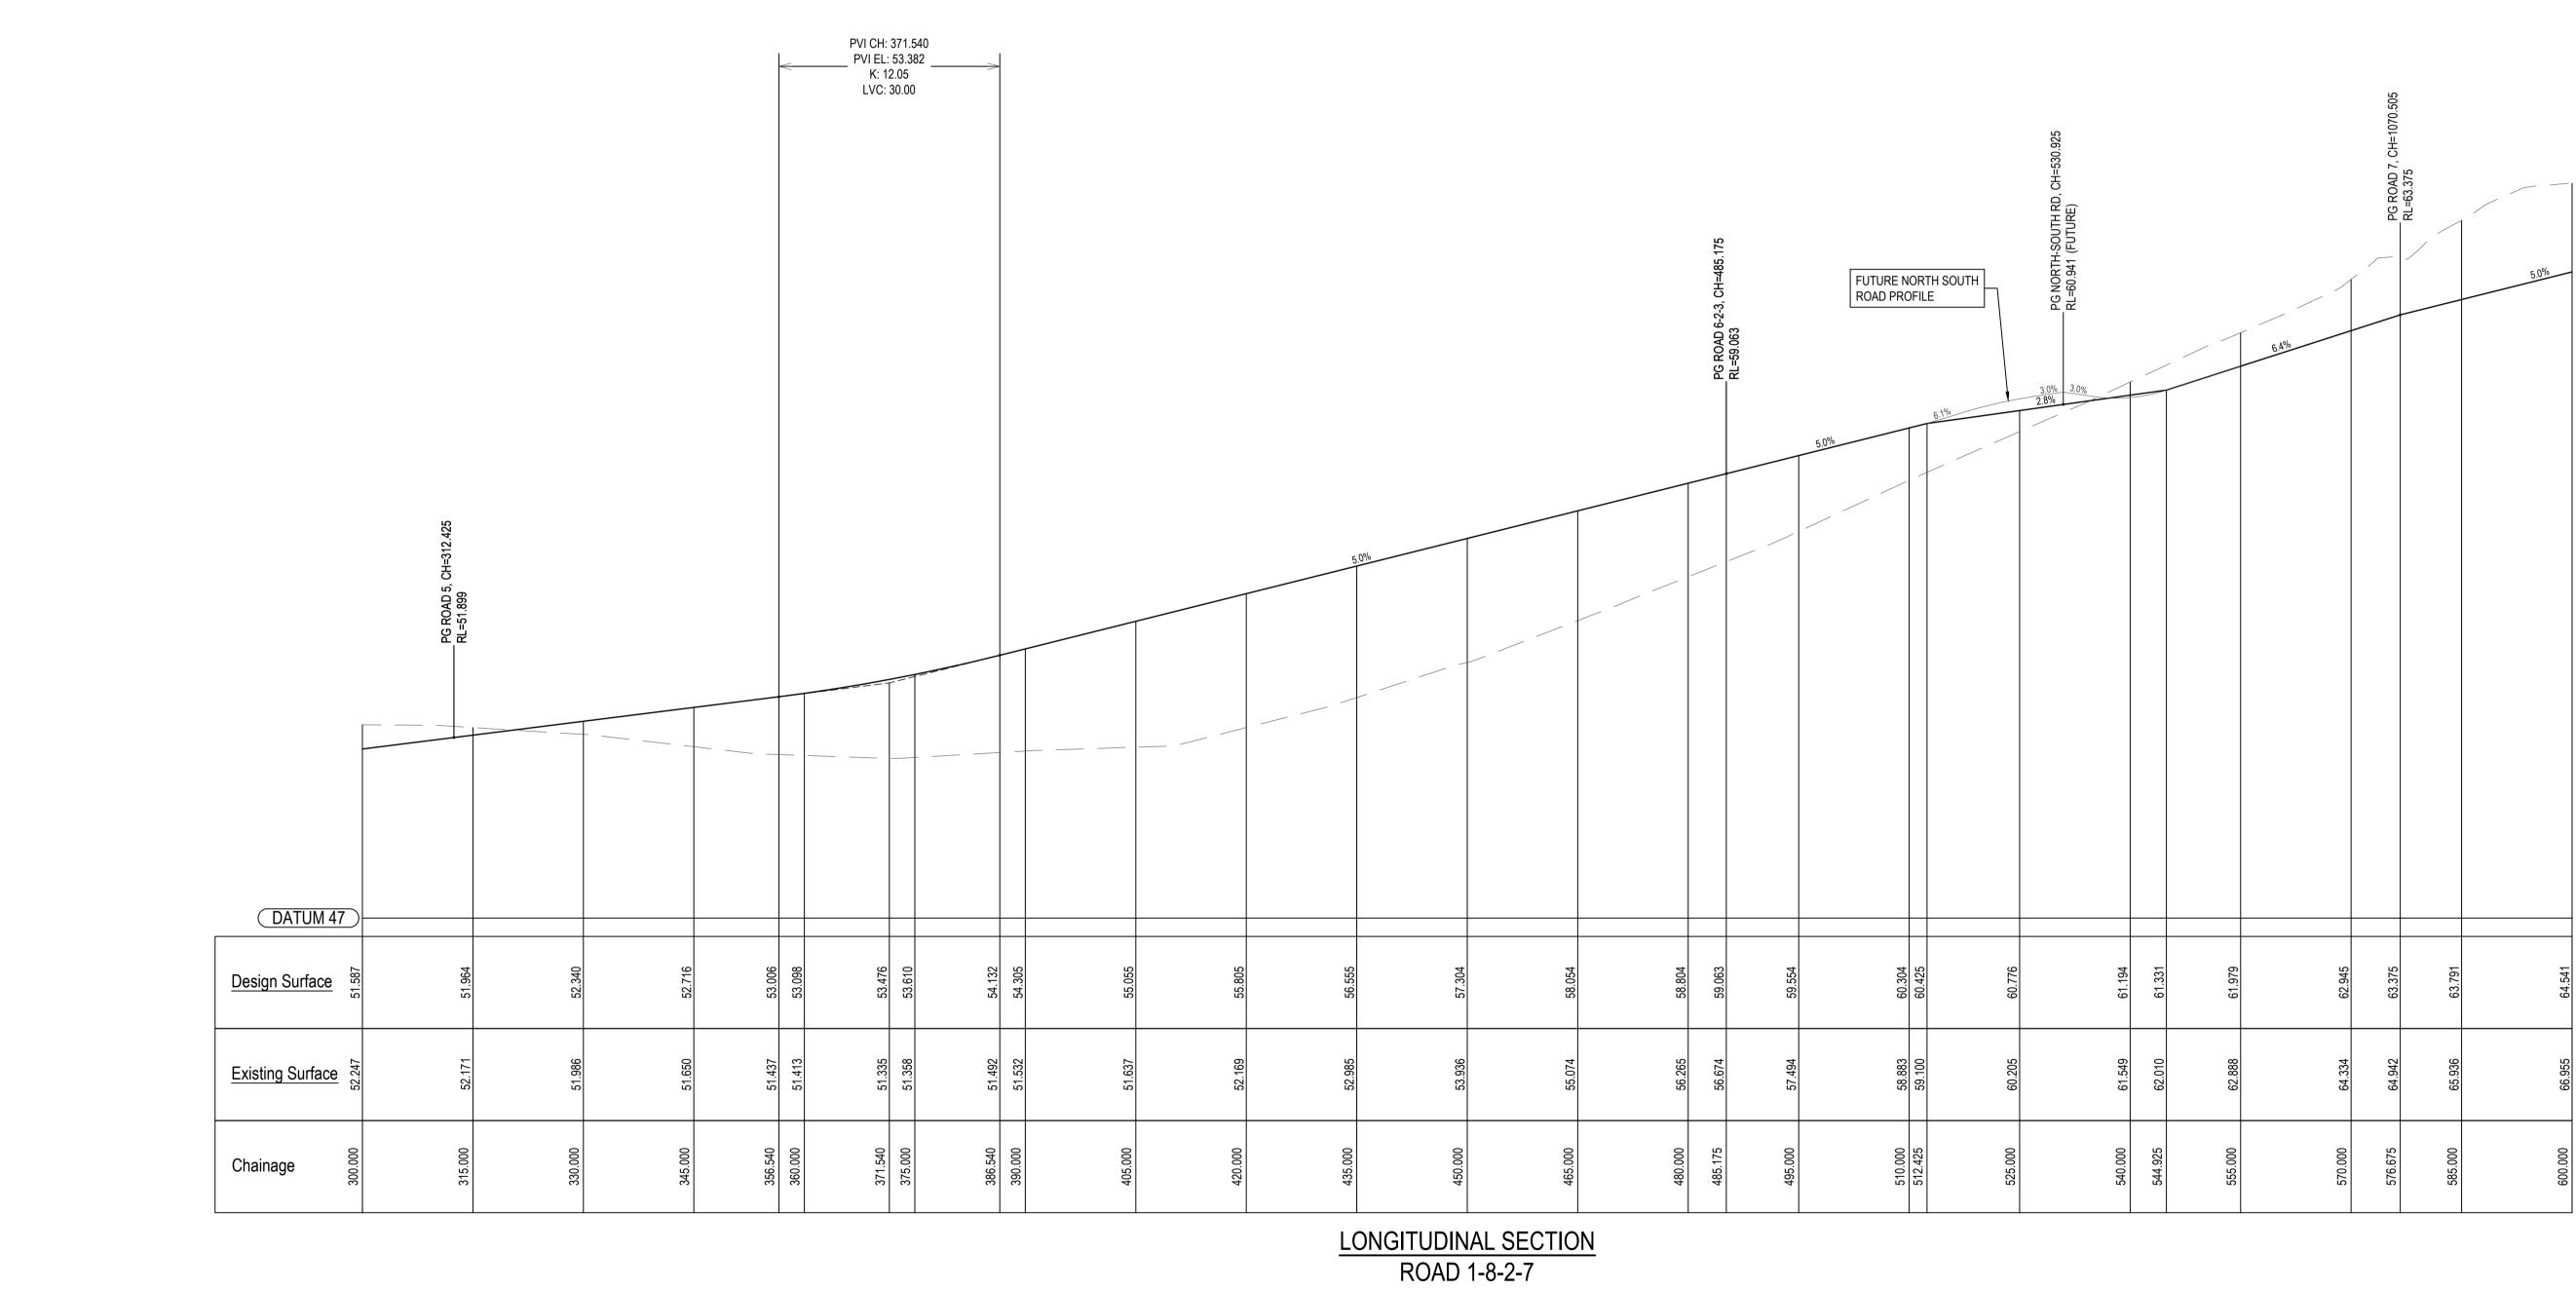

PROJECT: WALLACE INFRASTRUCTURE CIVIL WORKS for LOT 225 DP 246447 LOT 225, DP 246447 34 WYNDELLA ROAD LOCHINVAR NSW 2321

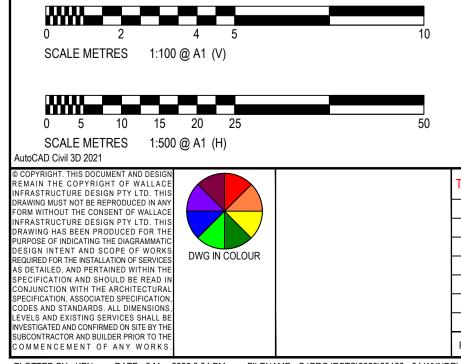
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ROAD 1-8-2 AND 9 ONGITUDINAL SECTIONS (2 OF 4)	SCALE: AS SHOWN				ORIG. SIZE		
	DRAWN	DESIGNED	CHECKED	APPROVED	ENDORSED	DATE	
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SPECIFICATION, ASSOCIATED SPECIFICATION, CODES AND STANDARDS. ALL DIMENSIONS,		В	З	COUNCIL AMENDMENTS - PREL S34	19.08.24	K.B.		info@bdaarch		
LEVELS AND EXISTING SERVICES SHALL BE INVESTIGATED AND CONFIRMED ON SITE BY THE		А	4	ISSUED FOR DA APPROVAL	02.02.24	K.B.		07 5555 2600		
SUBCONTRACTOR AND BUILDER PRIOR TO THE COMMENCEMENT OF ANY WORKS.		RE	EV	DESCRIPTION	DATE	APPV'D	ENDO'D			
PLOTTED BY:- KEN DATE:- 2 May 20	PLOTTED BY:- KEN DATE:- 2 May 2025 3 34 PM FILENAME:- O:\PROJECTS\2023\23128 - 34 WYNDELLA ROAD, LOCHINVAR\CAD\TITLE\23128_CIV_DA-[E]_34 WYNDELLA ROAD									

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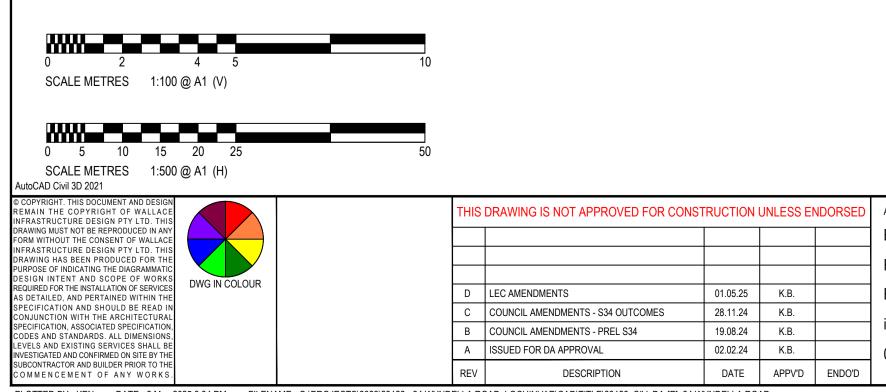
PROJECT: WALLACE INFRASTRUCTURE CIVIL WORKS for LOT 225 DP 246447 LOT 225, DP 246447 34 WYNDELLA ROAD LOCHINVAR NSW 2321

324 550 163	61.307	61.498	61.688	61.878
	59.324	59.459	59.550	59.463
855.000 870.000 885.000	855.000	870.000	885.000	000:006

DRAWING TITLE: CIVIL SERVICES	DRAWING STATUS DA APPROVAL NOT TO BE USED FOR CONSTRUCTI				ION	
ROAD 1-8-2 AND 9 LONGITUDINAL SECTIONS (3 OF 4)	SCALE: AS SHOW					.1
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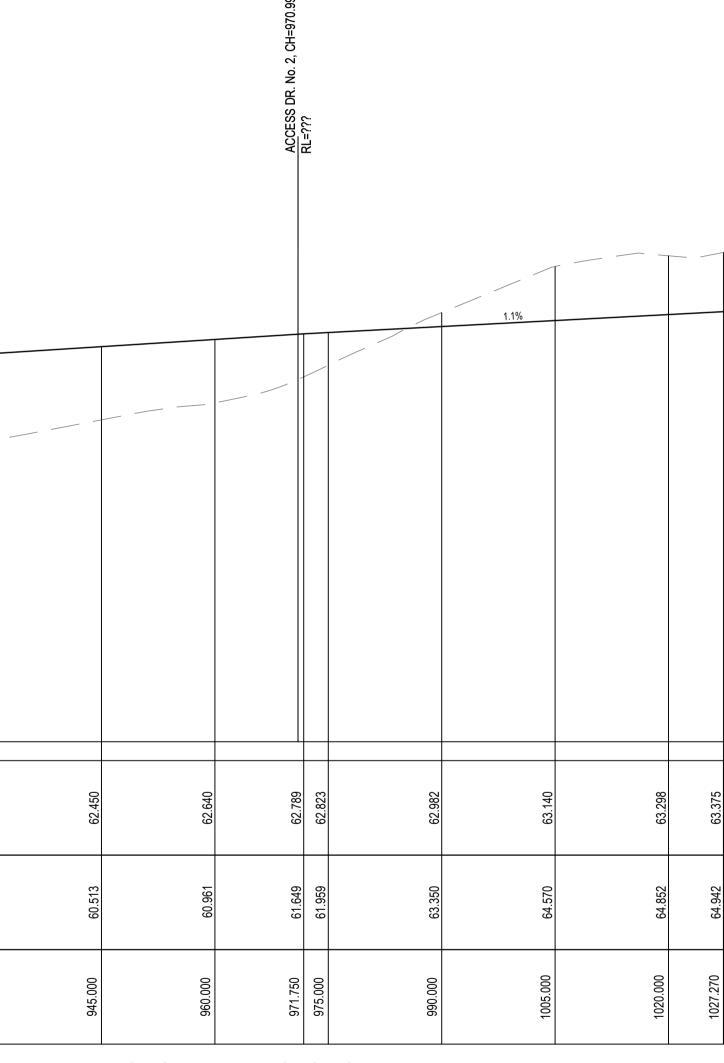
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DATUM 52				
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Existing Surface	59.463	59.506	59.956	
Chainage	000.006	915.000	930.000	

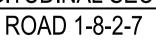

PLOTTED BY:- KEN DATE:- 2 May 2025 3 34 PM FILENAME:- O:\PROJECTS\2023\23128 - 34 WYNDELLA ROAD, LOCHINVAR\CAD\TITLE\23128\_CIV\_DA-[E]\_34 WYNDELLA ROAD

ARCHITECT: **BDA ARCHITECTS** PO Box 308 BROAD BEACH QLD 4218 info@bdaarch.com.au 07 5555 2600



LONGITUDINAL SECTION ROAD 1-8-2-7

CLIENT: Commercial 7 Pty Ltd ATF Commercial 7 Unit Trust PO Box 1138 HUNTERS HILL NSW 2110



PART OF WALLACE DESIGN GROUP PTY LTD ABN: 96 154 894 952 
 PO BOX 23, CHARLESTOWN, NSW 2290


 phone:
 (02) 49 294 109


 email:
 mail@wdegroup.com.au

 web:
 www.wdegroup.com.au

PROJECT: WALLACE INFRASTRUCTURE CIVIL WORKS for LOT 225 DP 246447 LOT 225, DP 246447 34 WYNDELLA ROAD LOCHINVAR NSW 2321


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	DRAWN	DESIGNED	CHECKED	APPROVED	ENDORSED	DATE	
	MS	KB	AS	KB		01.05.25	
	PROJECT No. DRAWING No.			No.		REV	
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PLOTTED BY:- KEN DATE:- 2 May 2025 3 34 PM FILENAME:- O:\PROJECTS\2023\23128 - 34 WYNDELLA ROAD, LOCHINVAR\CAD\TITLE\23128\_CIV\_DA-[E]\_34 WYNDELLA ROAD

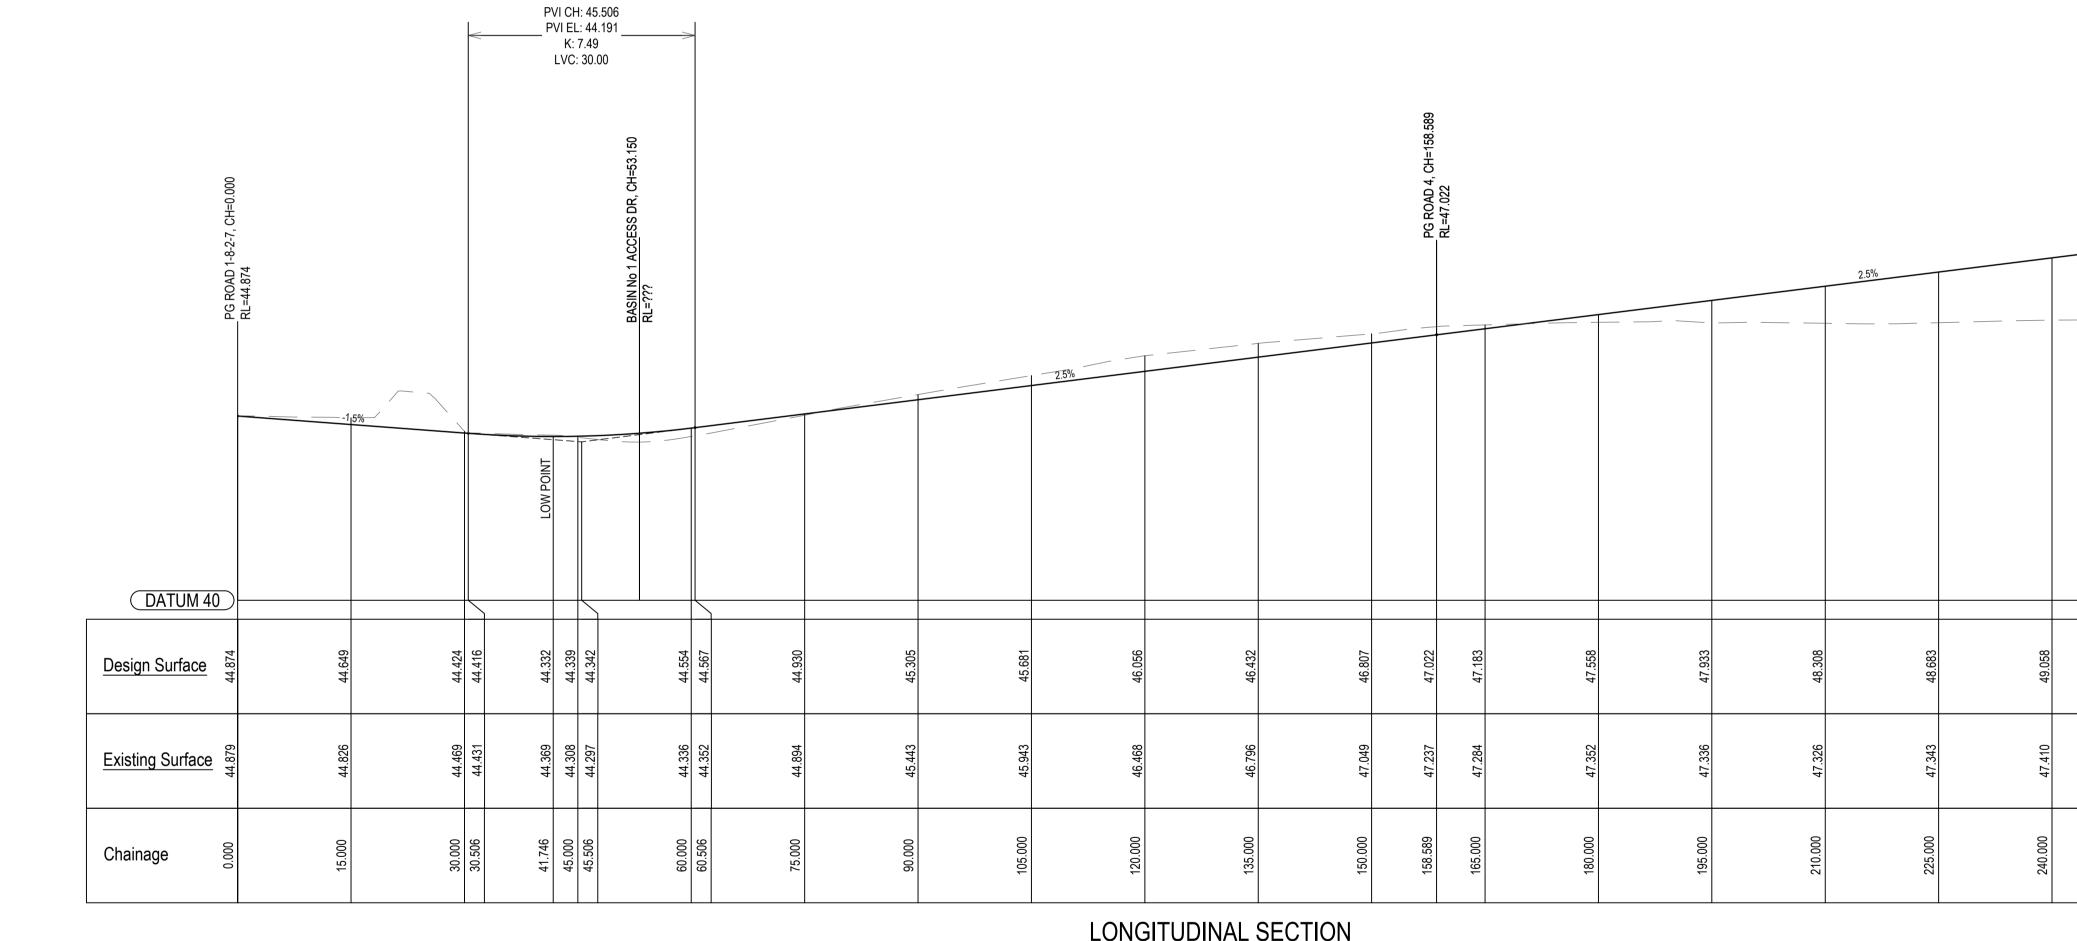ARCHITECT: **BDA ARCHITECTS** PO Box 308 BROAD BEACH QLD 4218 info@bdaarch.com.au 07 5555 2600

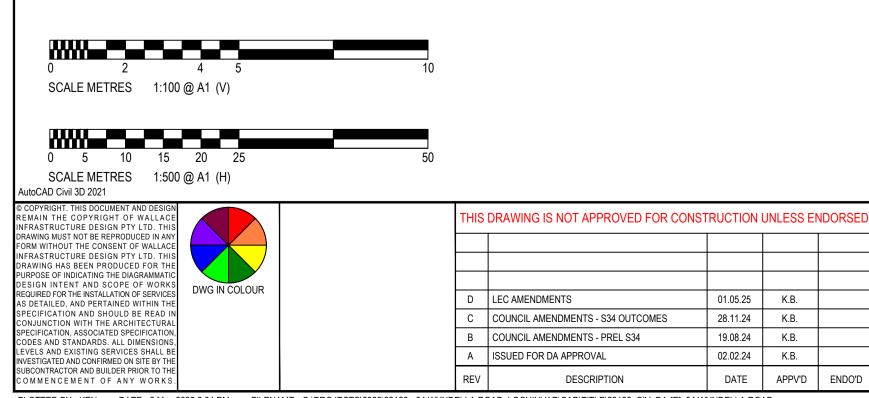





## WALLACE INFRASTRUCTURE CIVIL WORKS for LOT 225 DP 246447

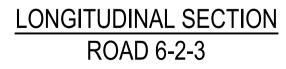PROJECT: LOT 225, DP 246447 34 WYNDELLA ROAD LOCHINVAR NSW 2321

49.433	49.558
47.426	47.395
255.000	260.000

DRAWING TITLE: CIVIL SERVICES	DRAWING STA					
ROAD 6-2 AND 3 LONGITUDINAL SECTIONS (1 OF 2)	SCALE: AS SHOWN				ORIG. SIZE	
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	MS	KB	AS	KB		01.05.25
	PROJECT No.	PROJECT No. DRAWING No.				REV
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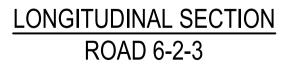
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02.02.24 K.B.

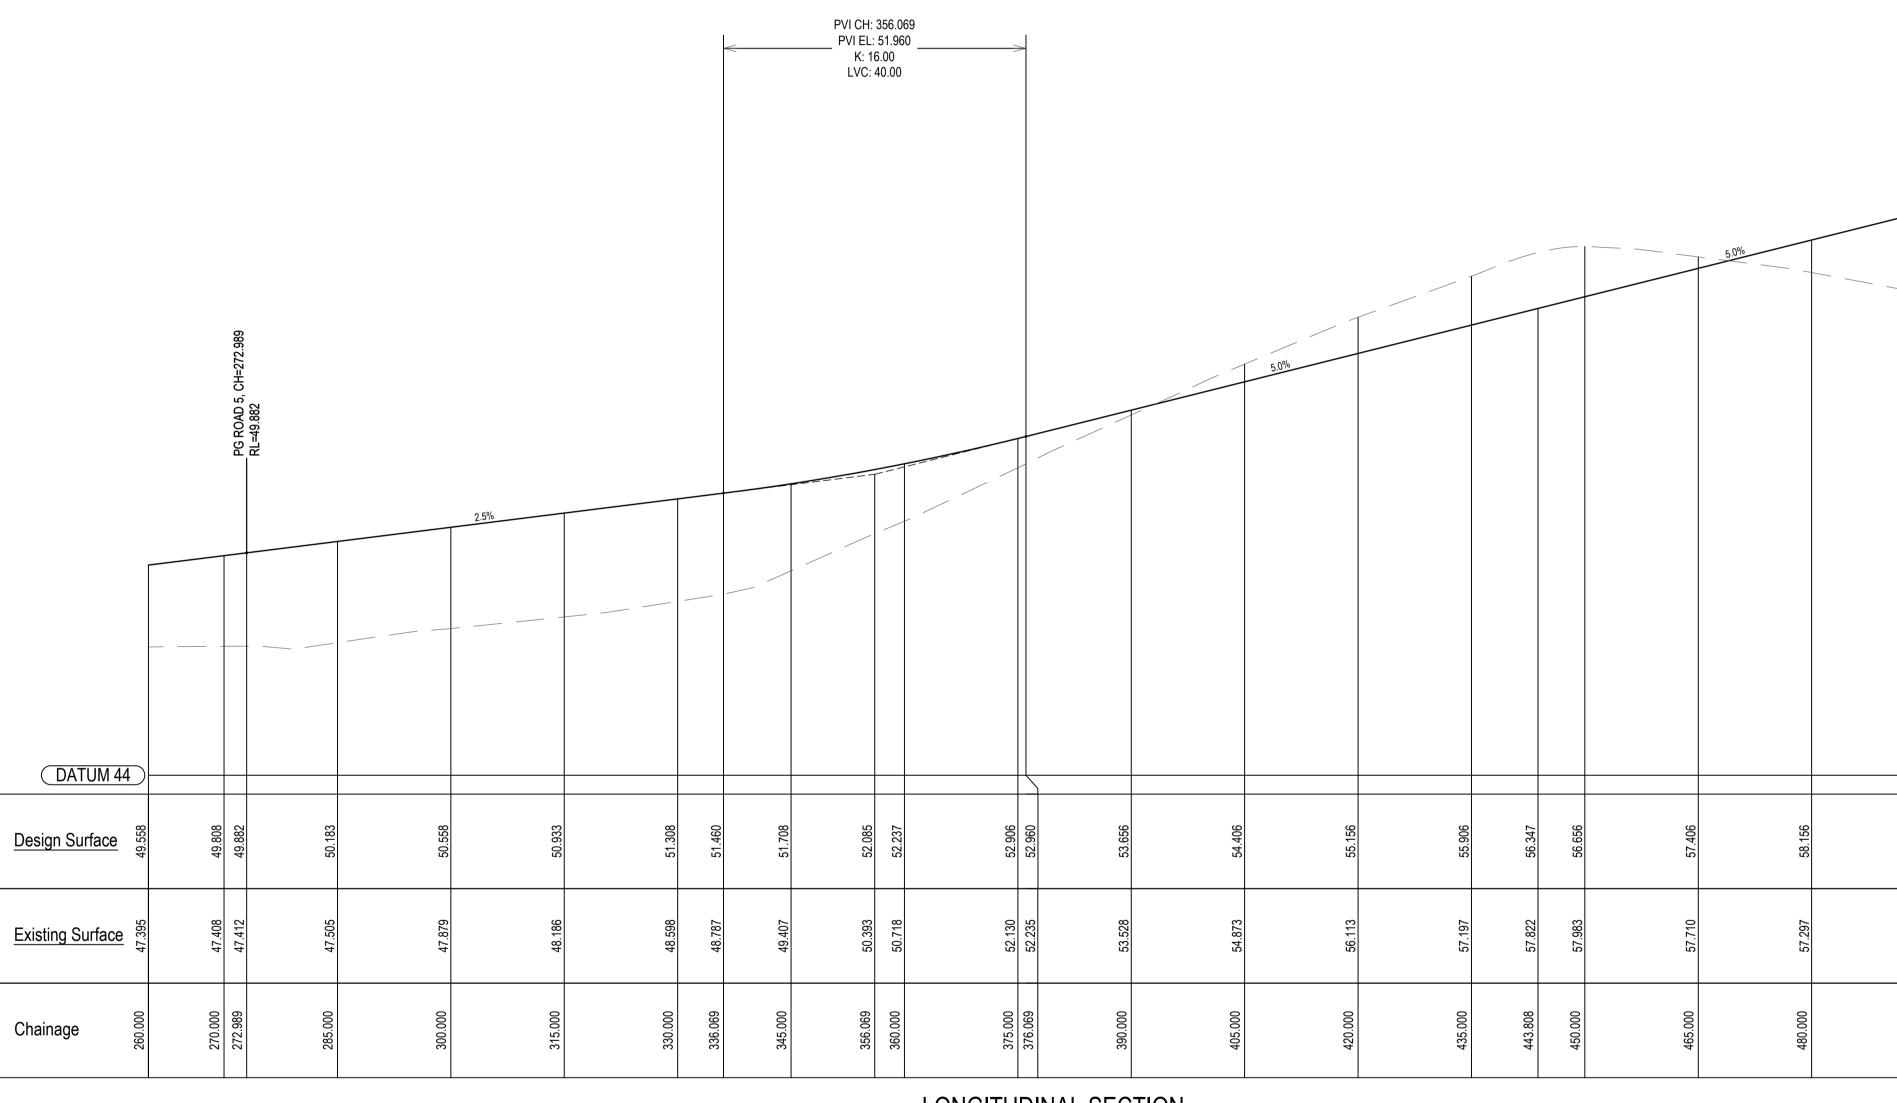
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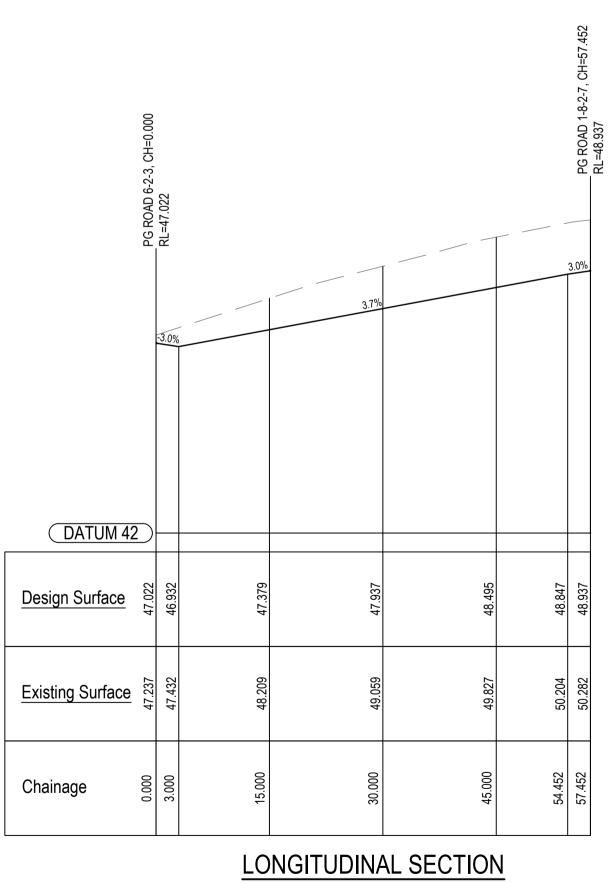


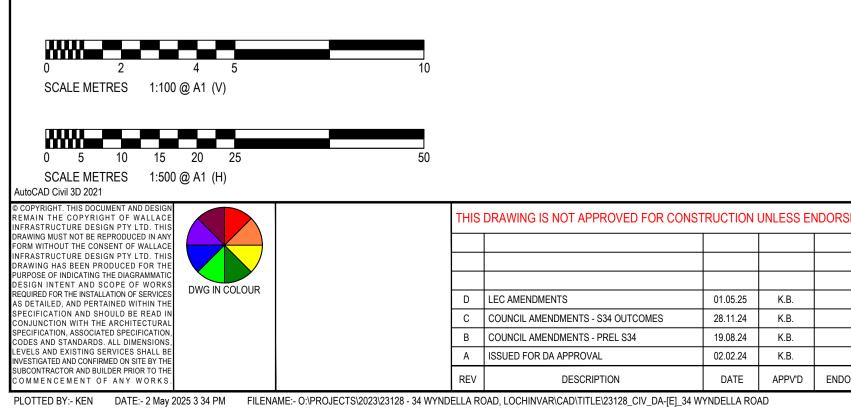WALLACE INFRASTRUCTURE CIVIL WORKS for LOT 225 DP 246447 LOT 225, DP 246447 34 WYNDELLA ROAD LOCHINVAR NSW 2321

PROJECT:



DRAWING TITLE: CIVIL SERVICES	DRAWING STA					
ROAD 6-2 AND 3 LONGITUDINAL SECTIONS (2 OF 2)	SCALE:				.1	
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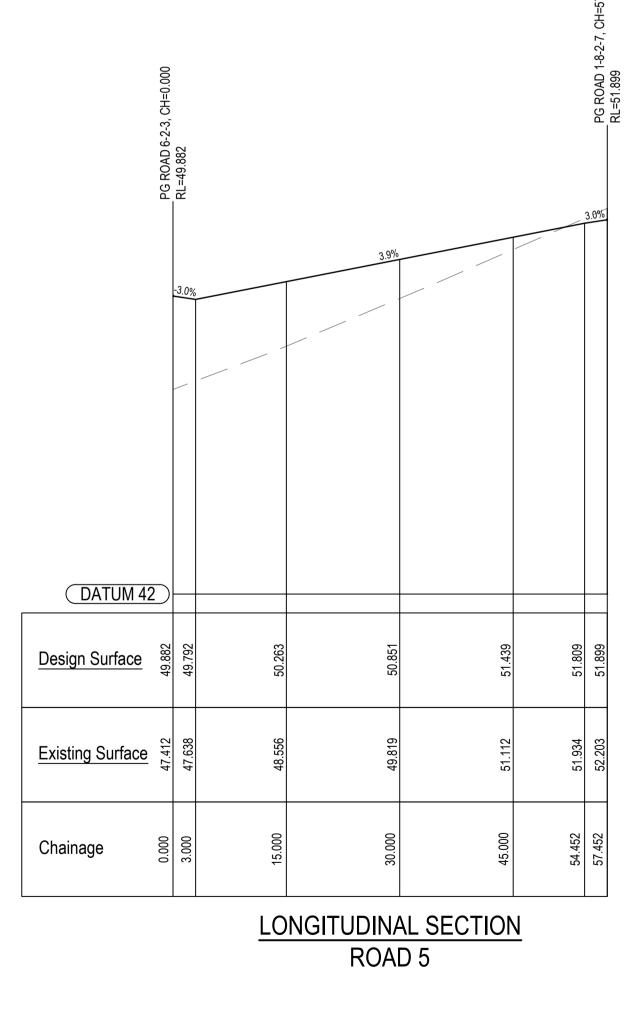
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SCALE METRES 1:500 @ A1 (H)
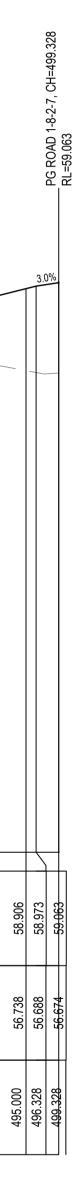
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INFRASTRUCTURE DESIGN PTY LTD. THIS DRAWING HAS BEEN PRODUCED FOR THE PURPOSE OF INDICATING THE DIAGRAMMATIC								PO Box 308
DESIGN INTENT AND SCOPE OF WORKS REQUIRED FOR THE INSTALLATION OF SERVICES AS DETAILED, AND PERTAINED WITHIN THE	DWG IN COLOUR			LEC AMENDMENTS	01.05.25	K.B.		BROAD BEACH QLD 4218
SPECIFICATION AND SHOULD BE READ IN CONJUNCTION WITH THE ARCHITECTURAL			С	COUNCIL AMENDMENTS - S34 OUTCOMES	28.11.24	K.B.		
SPECIFICATION, ASSOCIATED SPECIFICATION, CODES AND STANDARDS, ALL DIMENSIONS,			В	COUNCIL AMENDMENTS - PREL S34	19.08.24	K.B.		info@bdaarch.com.au
LEVELS AND EXISTING SERVICES SHALL BE INVESTIGATED AND CONFIRMED ON SITE BY THE			А	ISSUED FOR DA APPROVAL	02.02.24	K.B.		07 5555 2600
SUBCONTRACTOR AND BUILDER PRIOR TO THE COMMENCEMENT OF ANY WORKS.			REV	DESCRIPTION	DATE	APPV'D	ENDO'D	
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CLIENT: Commercial 7 Pty Ltd ATF Commercial 7 Unit Trust PO Box 1138 HUNTERS HILL NSW 2110




PROJECT: WALLACE INFRASTRUCTURE CIVIL WORKS for LOT 225 DB 246447 LOT 225, DP 246447 34 WYNDELLA ROAD LOCHINVAR NSW 2321


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	6.1%				
DATUM 54	)				
Design Surface	90C: 8C	59.415	59.697	60.249	
Existing Surface	900: 9C	59.826	60.042	60.662	
Chainage E	000.0	15.000	19.639	30.000	
L		I			



ARCHITECT: **BDA ARCHITECTS** PO Box 308 BROAD BEACH QLD 4218 info@bdaarch.com.au 07 5555 2600

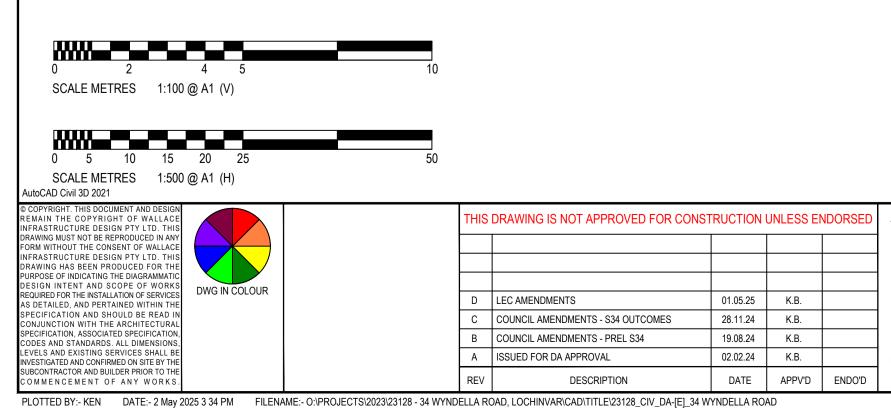

LONGITUDINAL SECTION NORTH-SOUTH ROAD

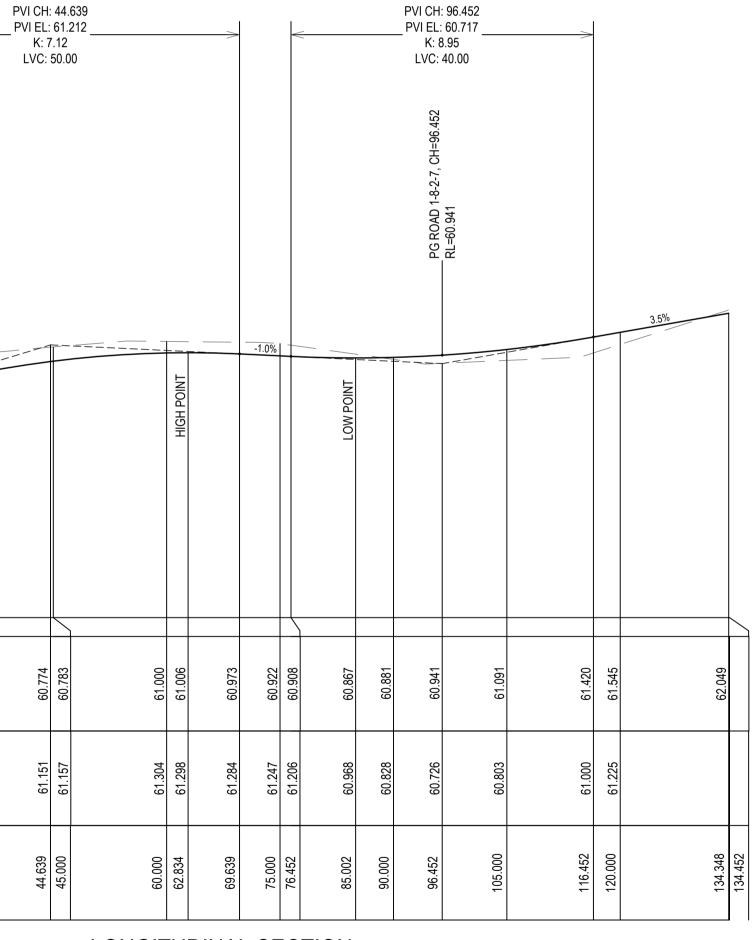CLIENT:



## WALLACE INFRASTRUCTURE CIVIL WORKS for LOT 225 DP 246447

PART OF WALLACE DESIGN GROUP PTY LTD ABN: 96 154 894 952 

 PO BOX 23, CHARLESTOWN, NSW 2290

 phone:
 (02) 49 294 109

 email:
 mail@wdegroup.com.au

 web:
 www.wdegroup.com.au

PROJECT: LOT 225, DP 246447 34 WYNDELLA ROAD LOCHINVAR NSW 2321

## RL, PG DATUM 36 Design Surface 42.49 42. Existing Surface 49 42. 5 5.500 Chainage


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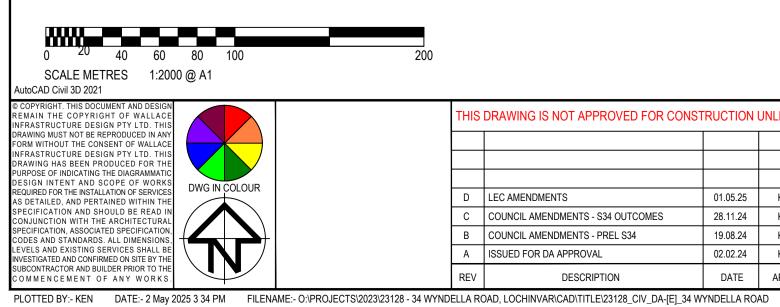
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LONGITUDINAL SECTION VISITOR PARKING ACCESS DR.

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42.950	43.409	43.547	
20.000	30.000	33.029	

4.6%



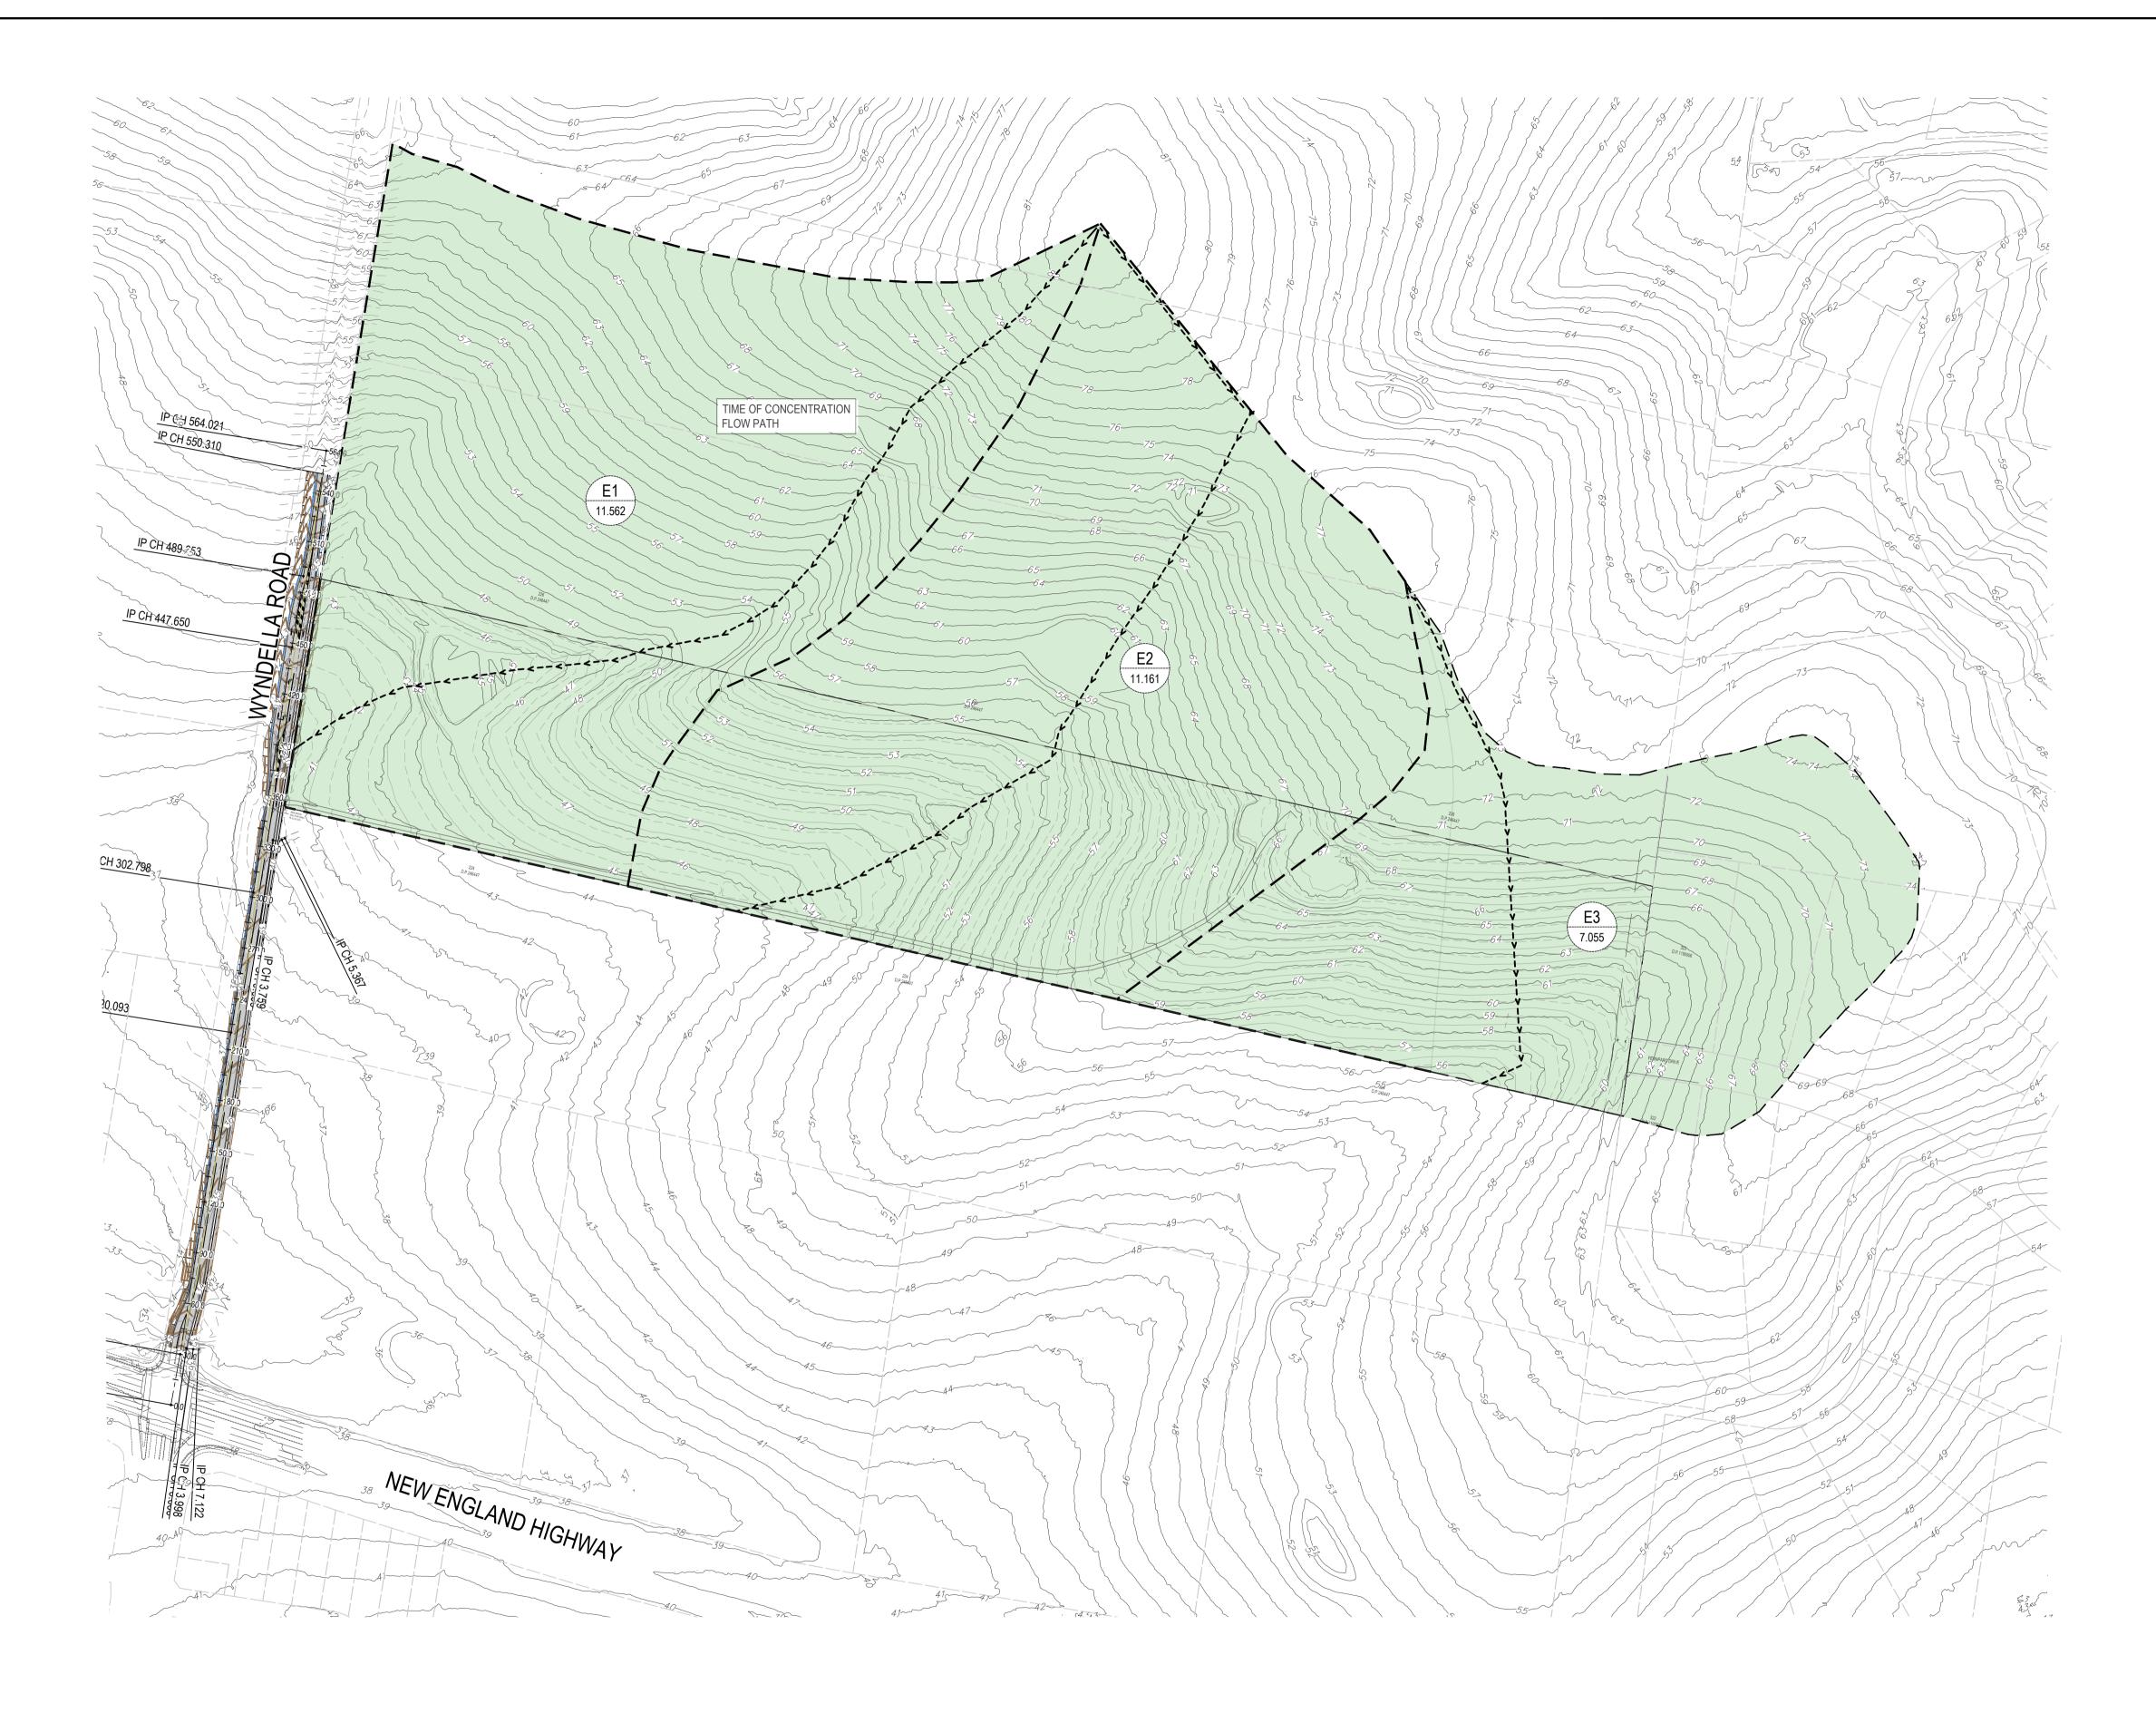

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					PO Box 308
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А	ISSUED FOR DA APPROVAL	02.02.24	K.B.		07 5555 2600
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## WALLACE INFRASTRUCTURE CIVIL WORKS for DESIGN PTY LTD

LOT 225, DP 246447 34 WYNDELLA ROAD LOCHINVAR NSW 2321


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**CIVIL SERVICES** EXISTING STO CATCHMENT

DRAWING TITLE:

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					PO Box 308
D	LEC AMENDMENTS	01.05.25	K.B.		BROAD BEACH
С	COUNCIL AMENDMENTS - S34 OUTCOMES	28.11.24	K.B.		
В	COUNCIL AMENDMENTS - PREL S34	19.08.24	K.B.		info@bdaarch.co
А	ISSUED FOR DA APPROVAL	02.02.24	K.B.		07 5555 2600
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## WALLACE INFRASTRUCTURE CIVIL WORKS for DESIGN PTY LTD


PART OF WALLACE DESIGN GROUP PTY LTD

PROJECT: LOT 225, DP 246447 34 WYNDELLA ROAD LOCHINVAR NSW 2321

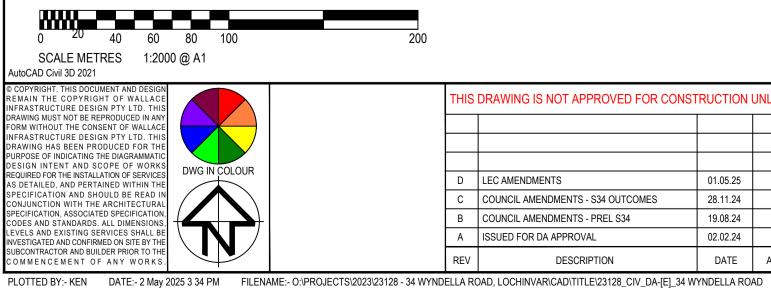**CIVIL SERVICES** DEVELOPED STORM CATCHMENT PLAN

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RMWATER	SCALE:	SCALE: ORIG. SIZE				
	DRAWN	DESIGNED	CHECKED	ENDORSED	DATE	
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OMMENCEMENT OF ANY WORKS.

B COUNCIL AMENDMENTS - PREL S34 19.08.24 K.B. A ISSUED FOR DA APPROVAL 02.02.24 K.B. DATE APPV'D ENDO'D REV DESCRIPTION PLOTTED BY:- KEN DATE:- 2 May 2025 3 34 PM FILENAME:- O:\PROJECTS\2023\23128 - 34 WYNDELLA ROAD, LOCHINVAR\CAD\TITLE\23128\_CIV\_DA-[E]\_34 WYNDELLA ROAD

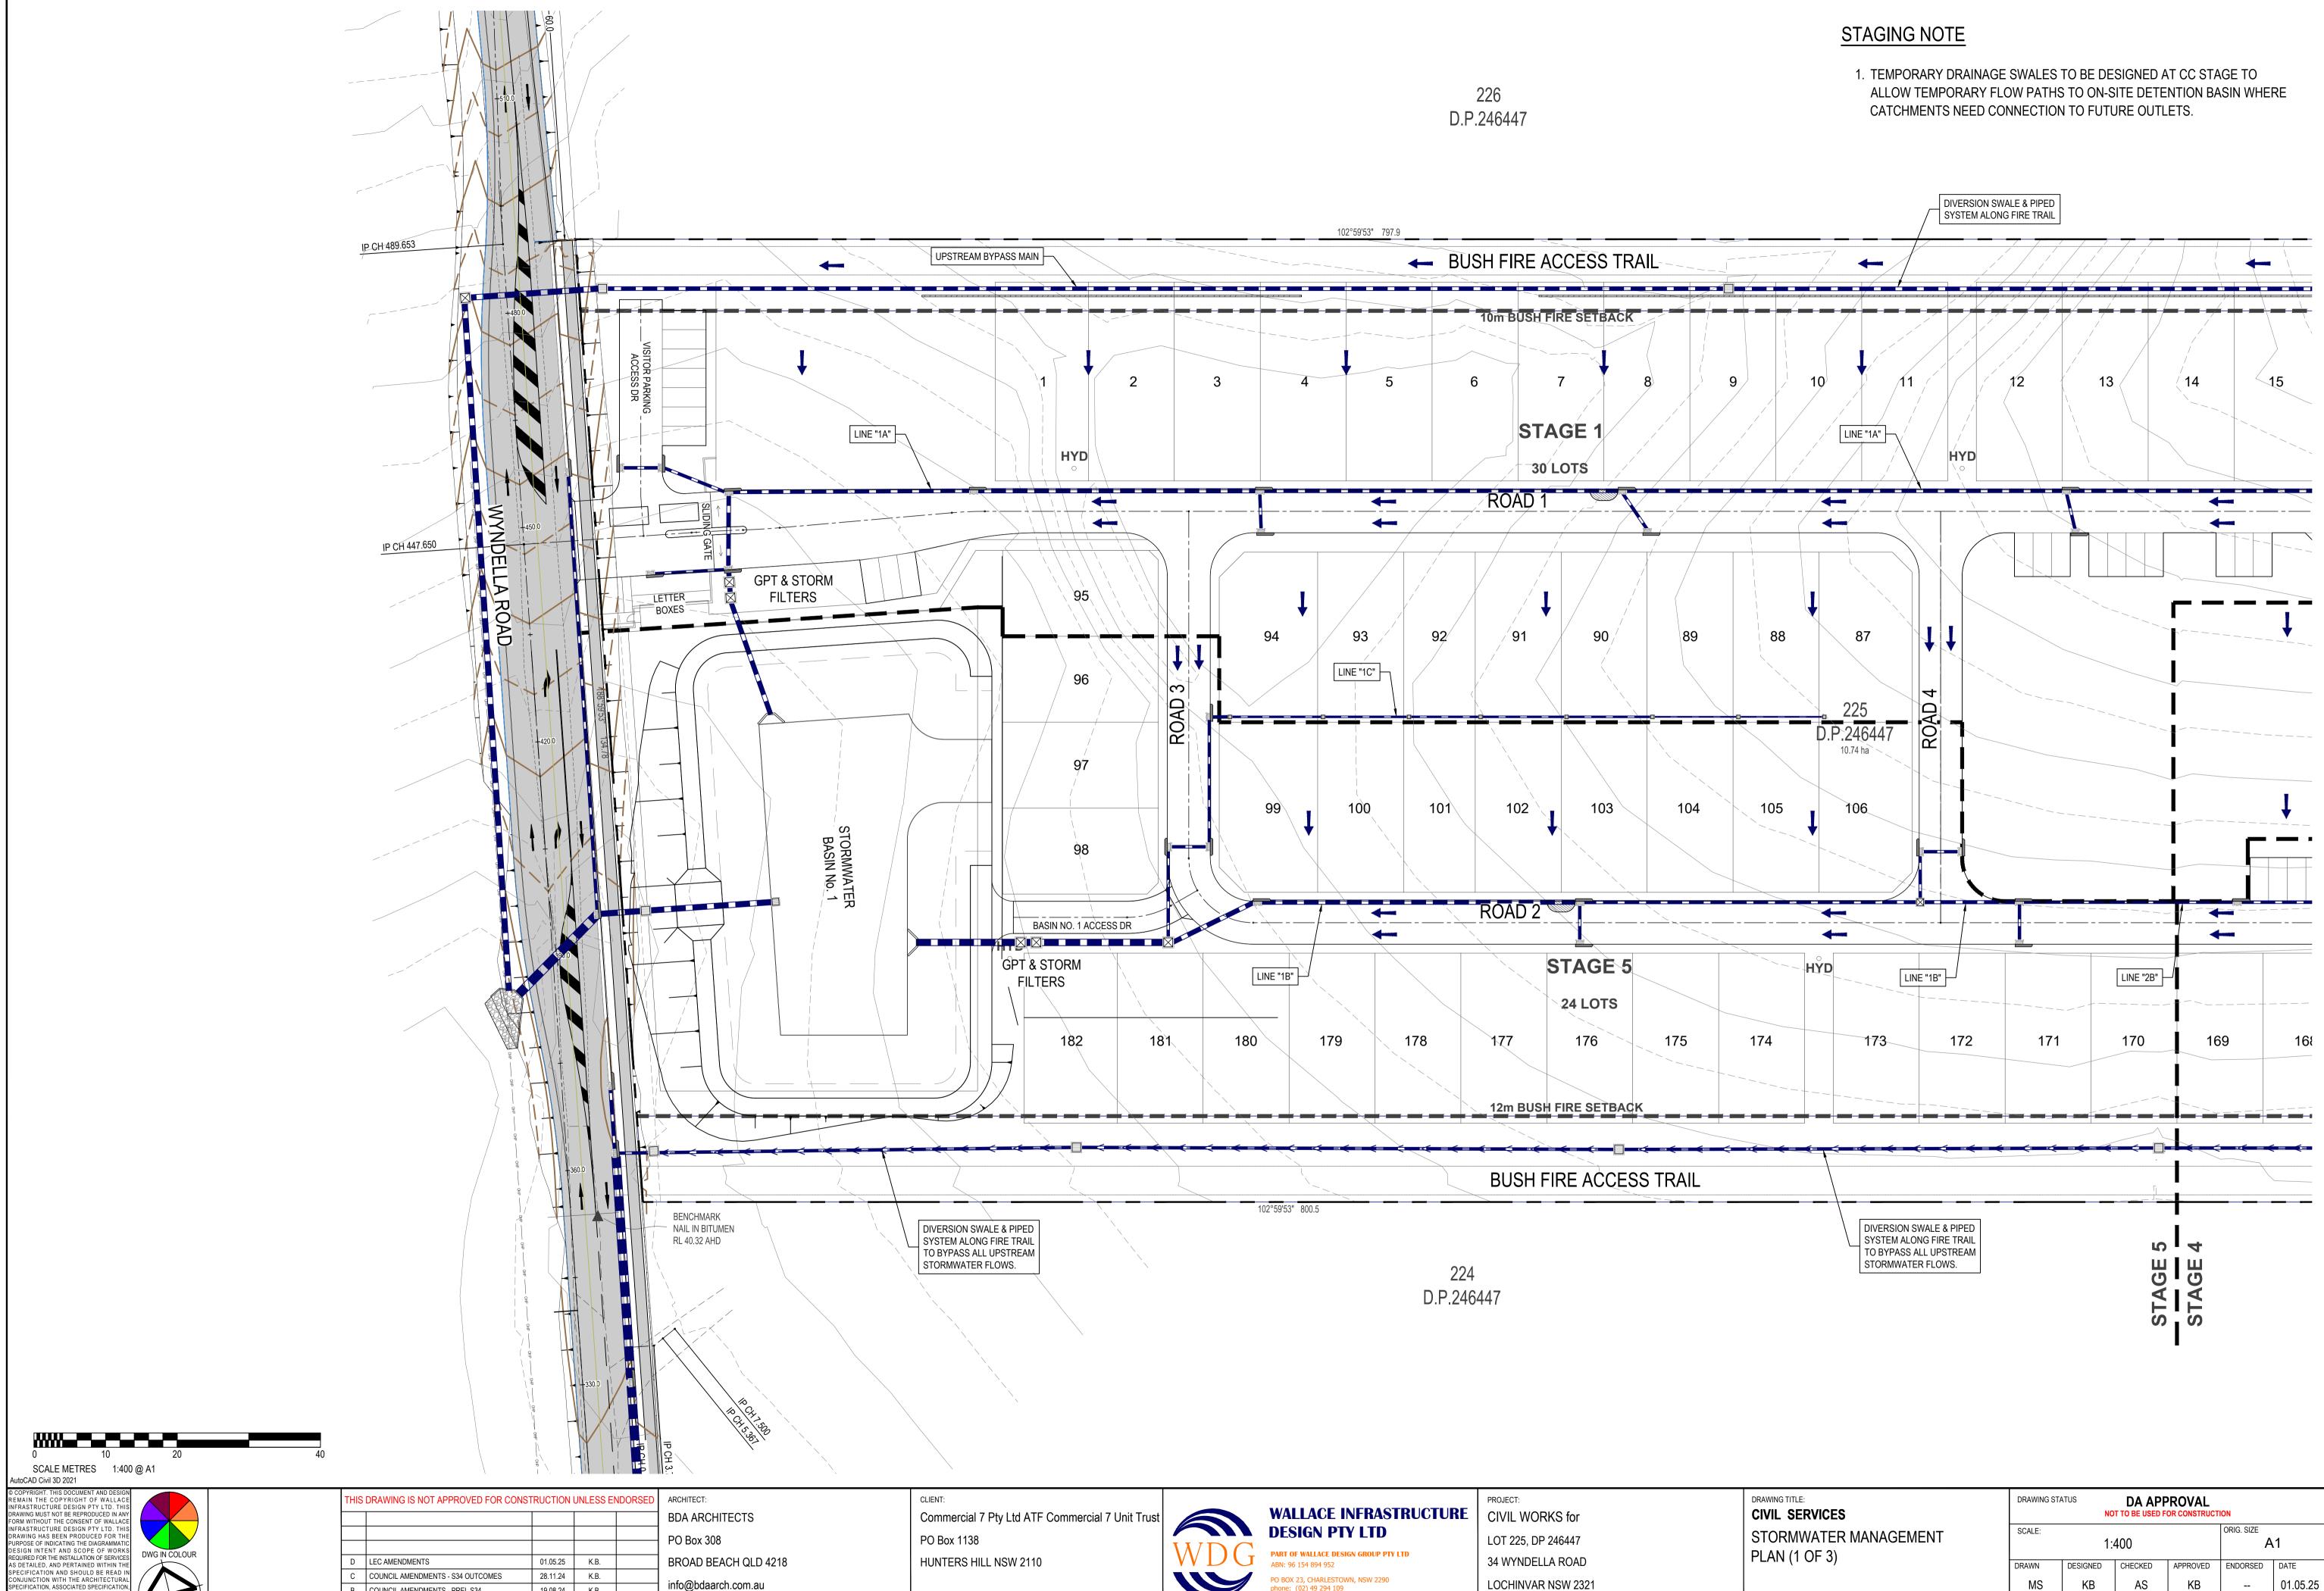info@bdaarch.com.au 07 5555 2600





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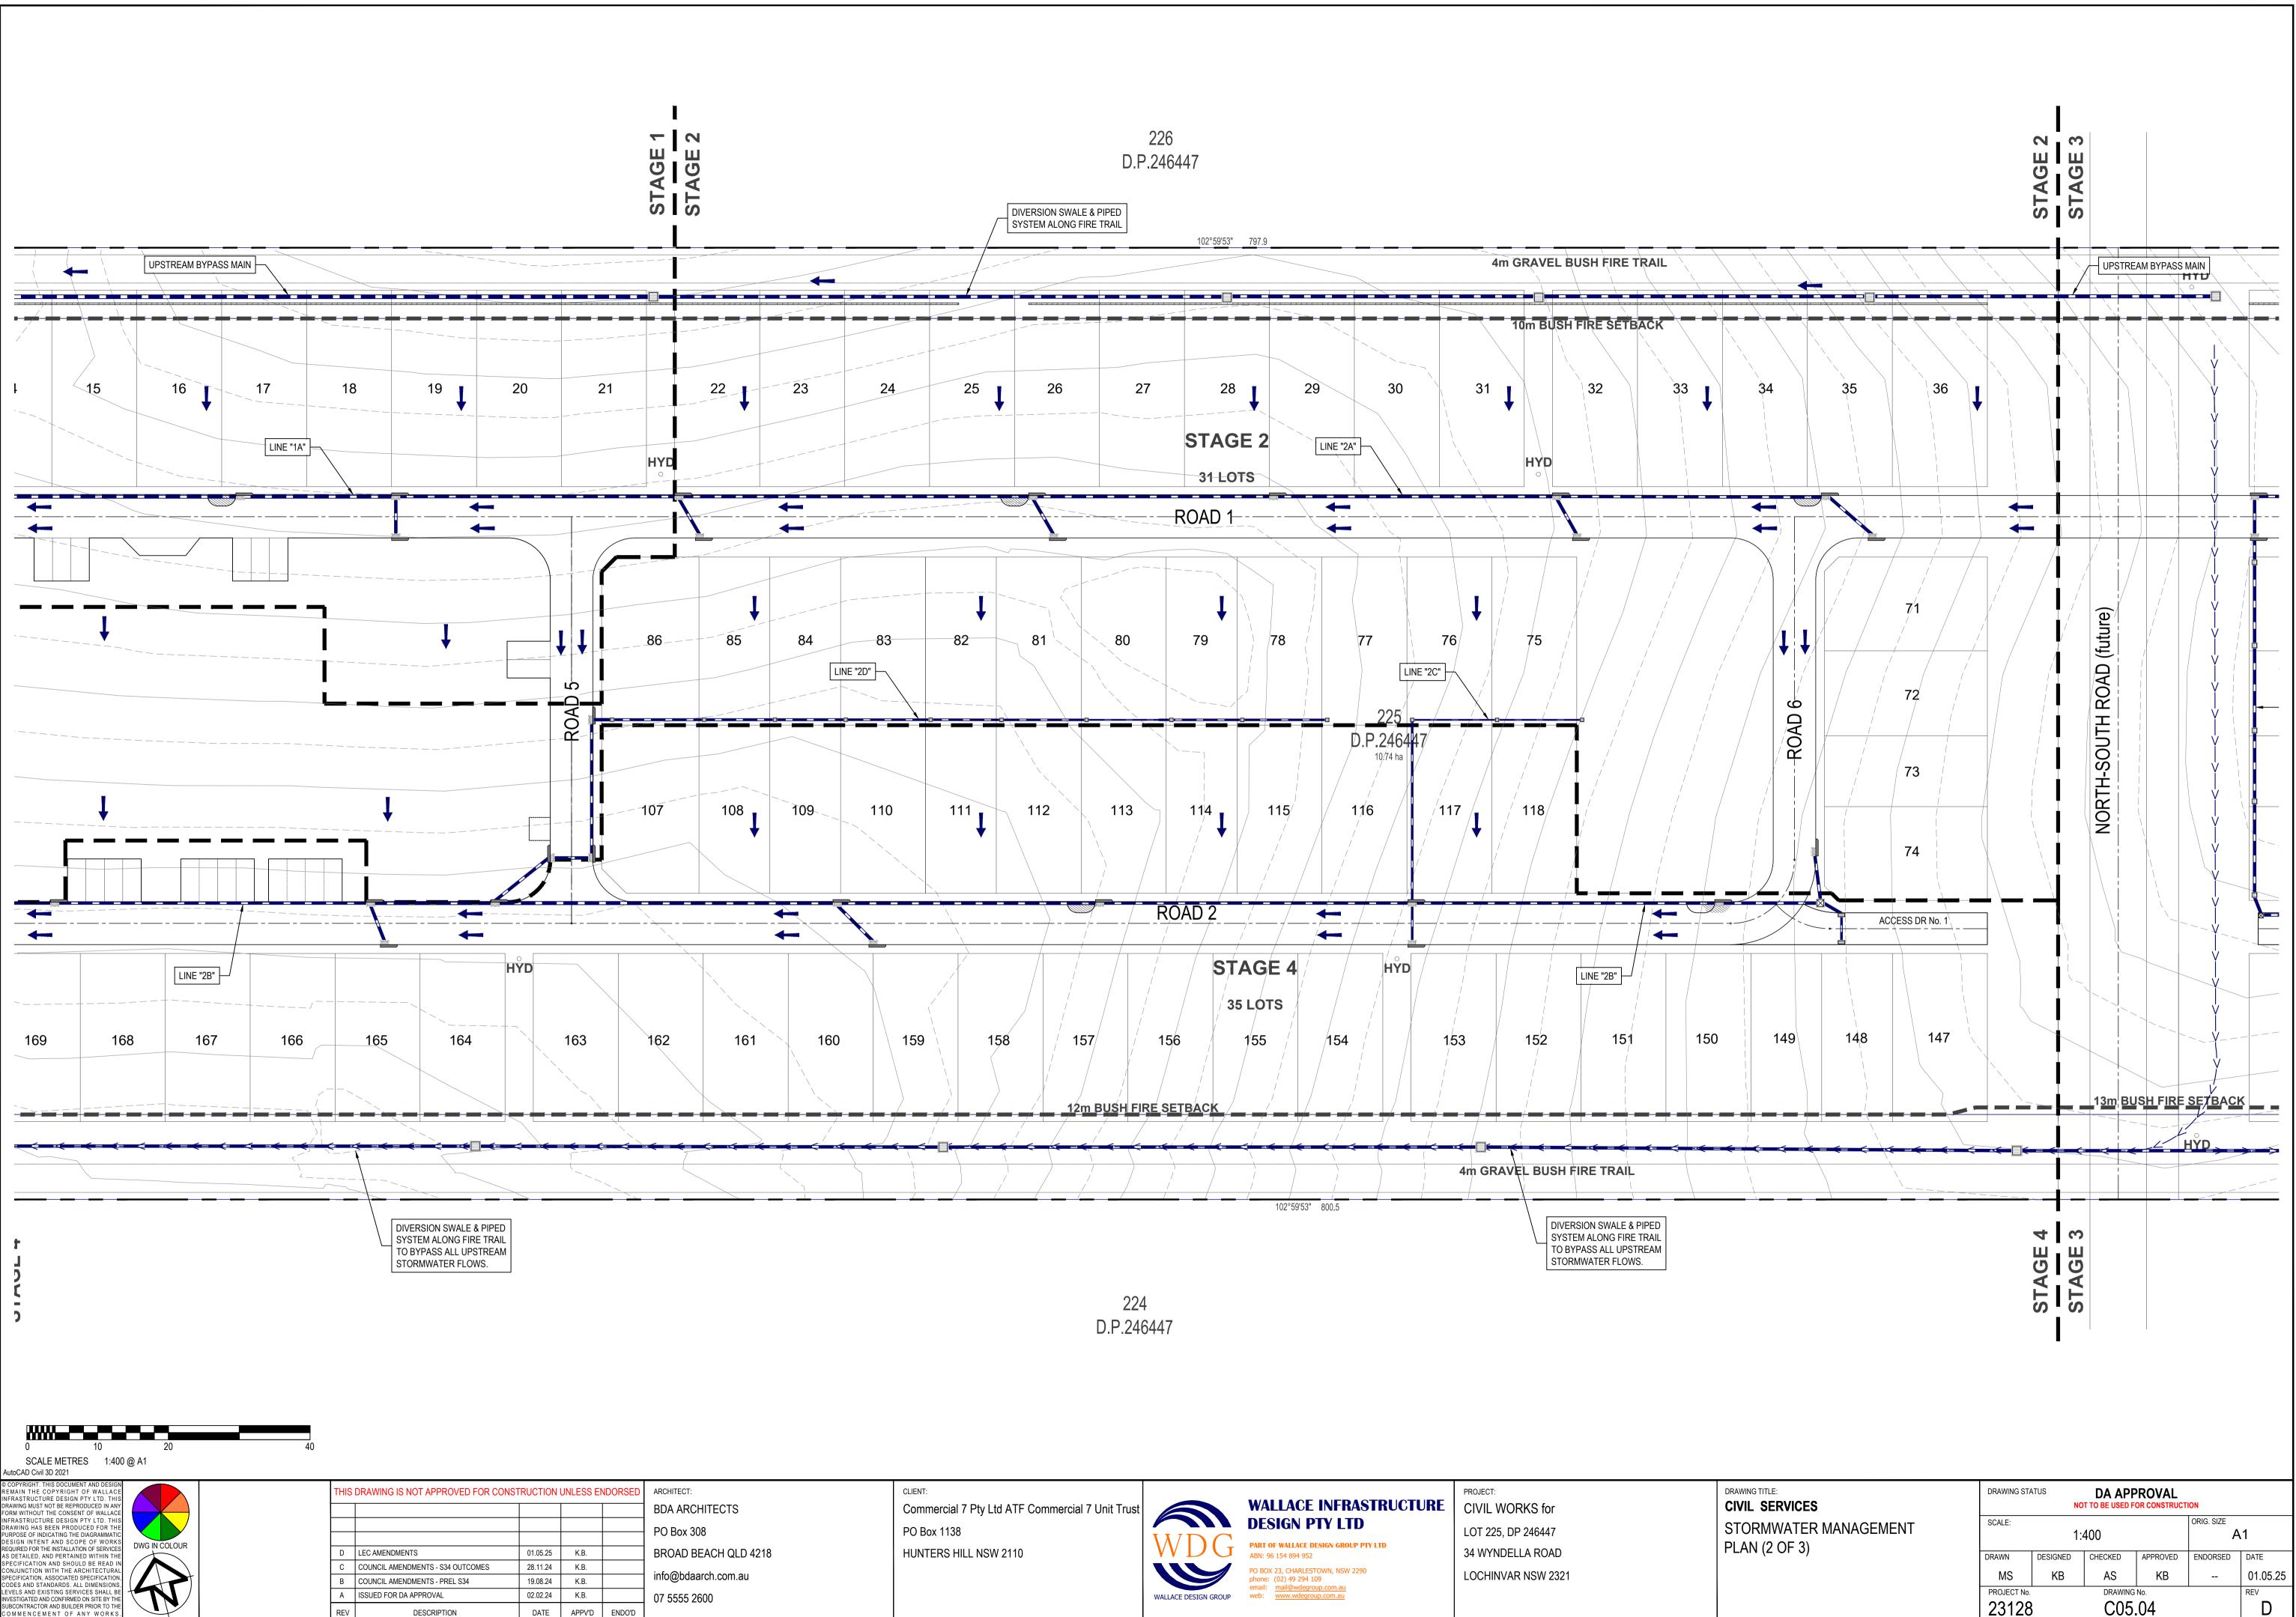
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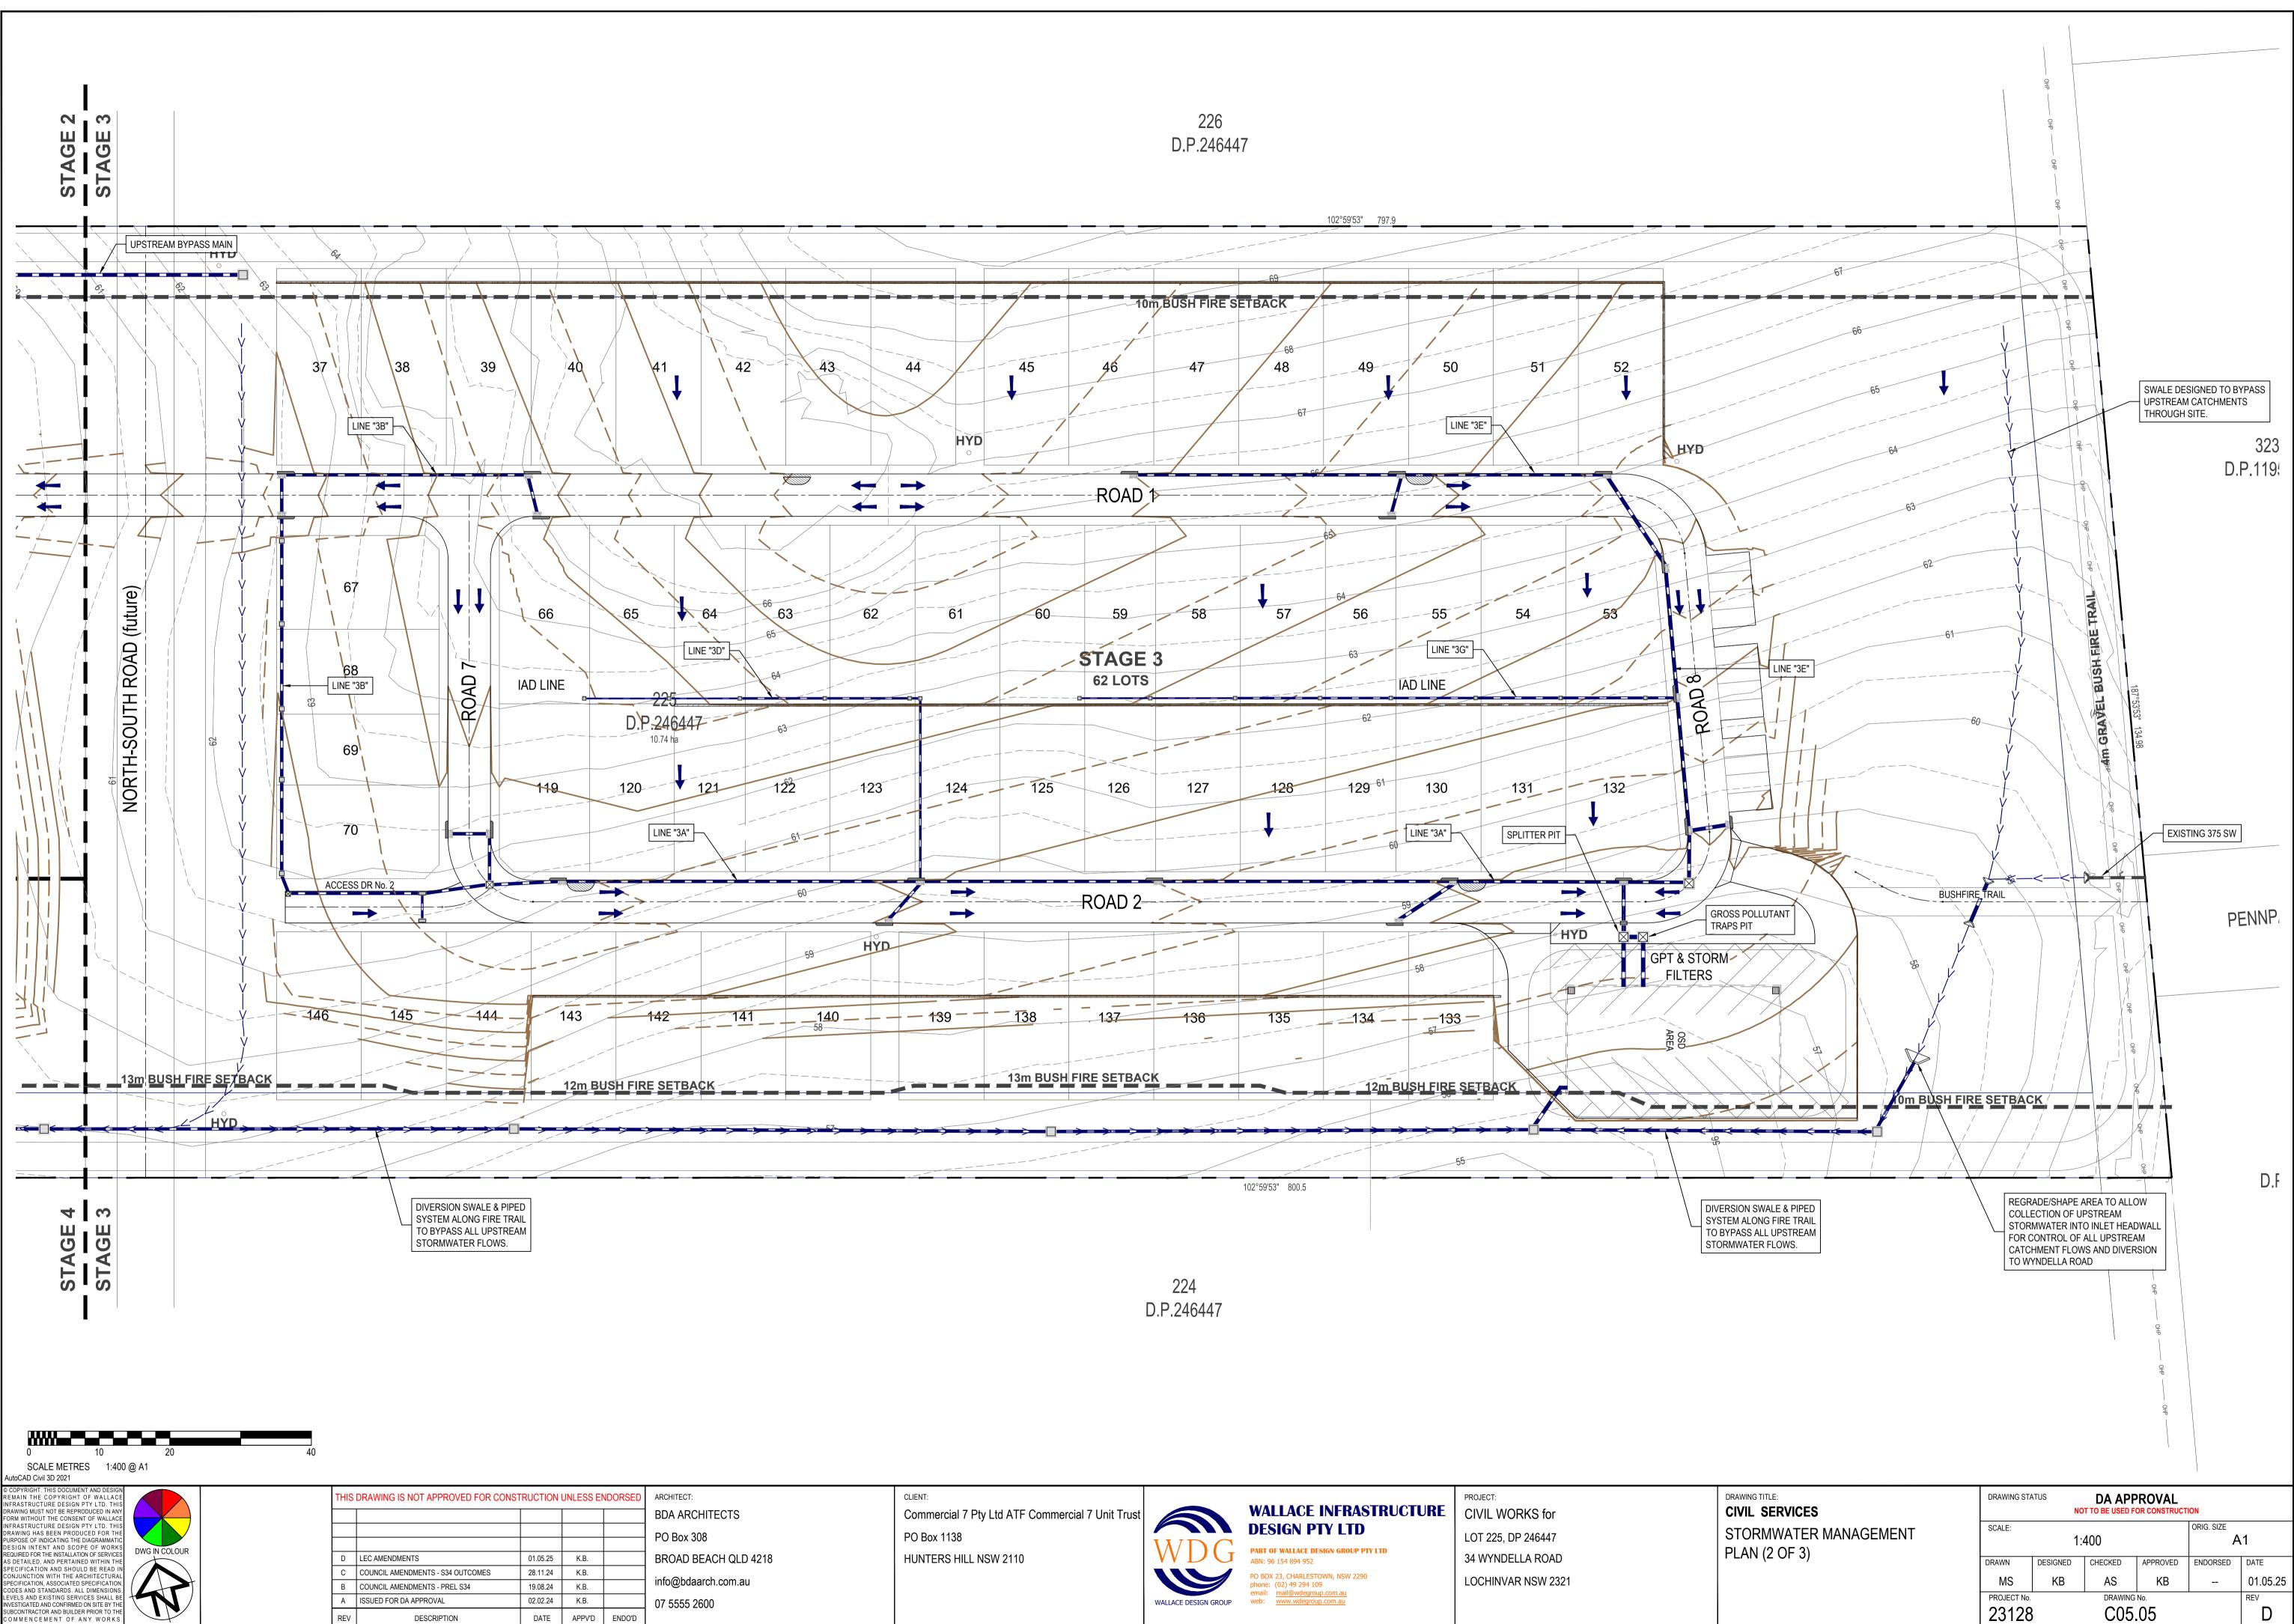
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OMMENCEMENT OF ANY WORKS.


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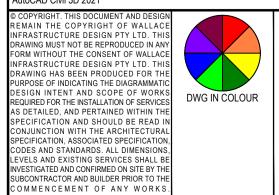


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### SCALE METRES 1:50 @ A1

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DESIGN INTENT AND SCOPE OF WORKS REQUIRED FOR THE INSTALLATION OF SERVICES AS DETAILED, AND PERTAINED WITHIN THE SPECIFICATION AND SHOULD BE READ IN	DWG IN COLOUR	-	D	LEC AMENDMENTS	01.05.25	K.B.		BROAD BEACH QL
CONJUNCTION WITH THE ARCHITECTURAL			С	COUNCIL AMENDMENTS - S34 OUTCOMES	28.11.24	K.B.		info@bdaarch.com.a
SPECIFICATION, ASSOCIATED SPECIFICATION, CODES AND STANDARDS. ALL DIMENSIONS,			В	COUNCIL AMENDMENTS - PREL S34	19.08.24	K.B.		
LEVELS AND EXISTING SERVICES SHALL BE INVESTIGATED AND CONFIRMED ON SITE BY THE			А	ISSUED FOR DA APPROVAL	02.02.24	K.B.		07 5555 2600
SUBCONTRACTOR AND BUILDER PRIOR TO THE COMMENCEMENT OF ANY WORKS.			REV	DESCRIPTION	DATE	APPV'D	ENDO'D	
PLOTTED BY:- KEN DATE:- 2 May 24	025 3 34 PM FILEN	AME:- 0:\PROJECTS\2023\23128 - 34 WYNDE	ELLA RO	DAD, LOCHINVAR\CAD\TITLE\23128_CIV_DA-[E]_34 \	VYNDELLA RO	AD		

TS QLD 4218 1.au

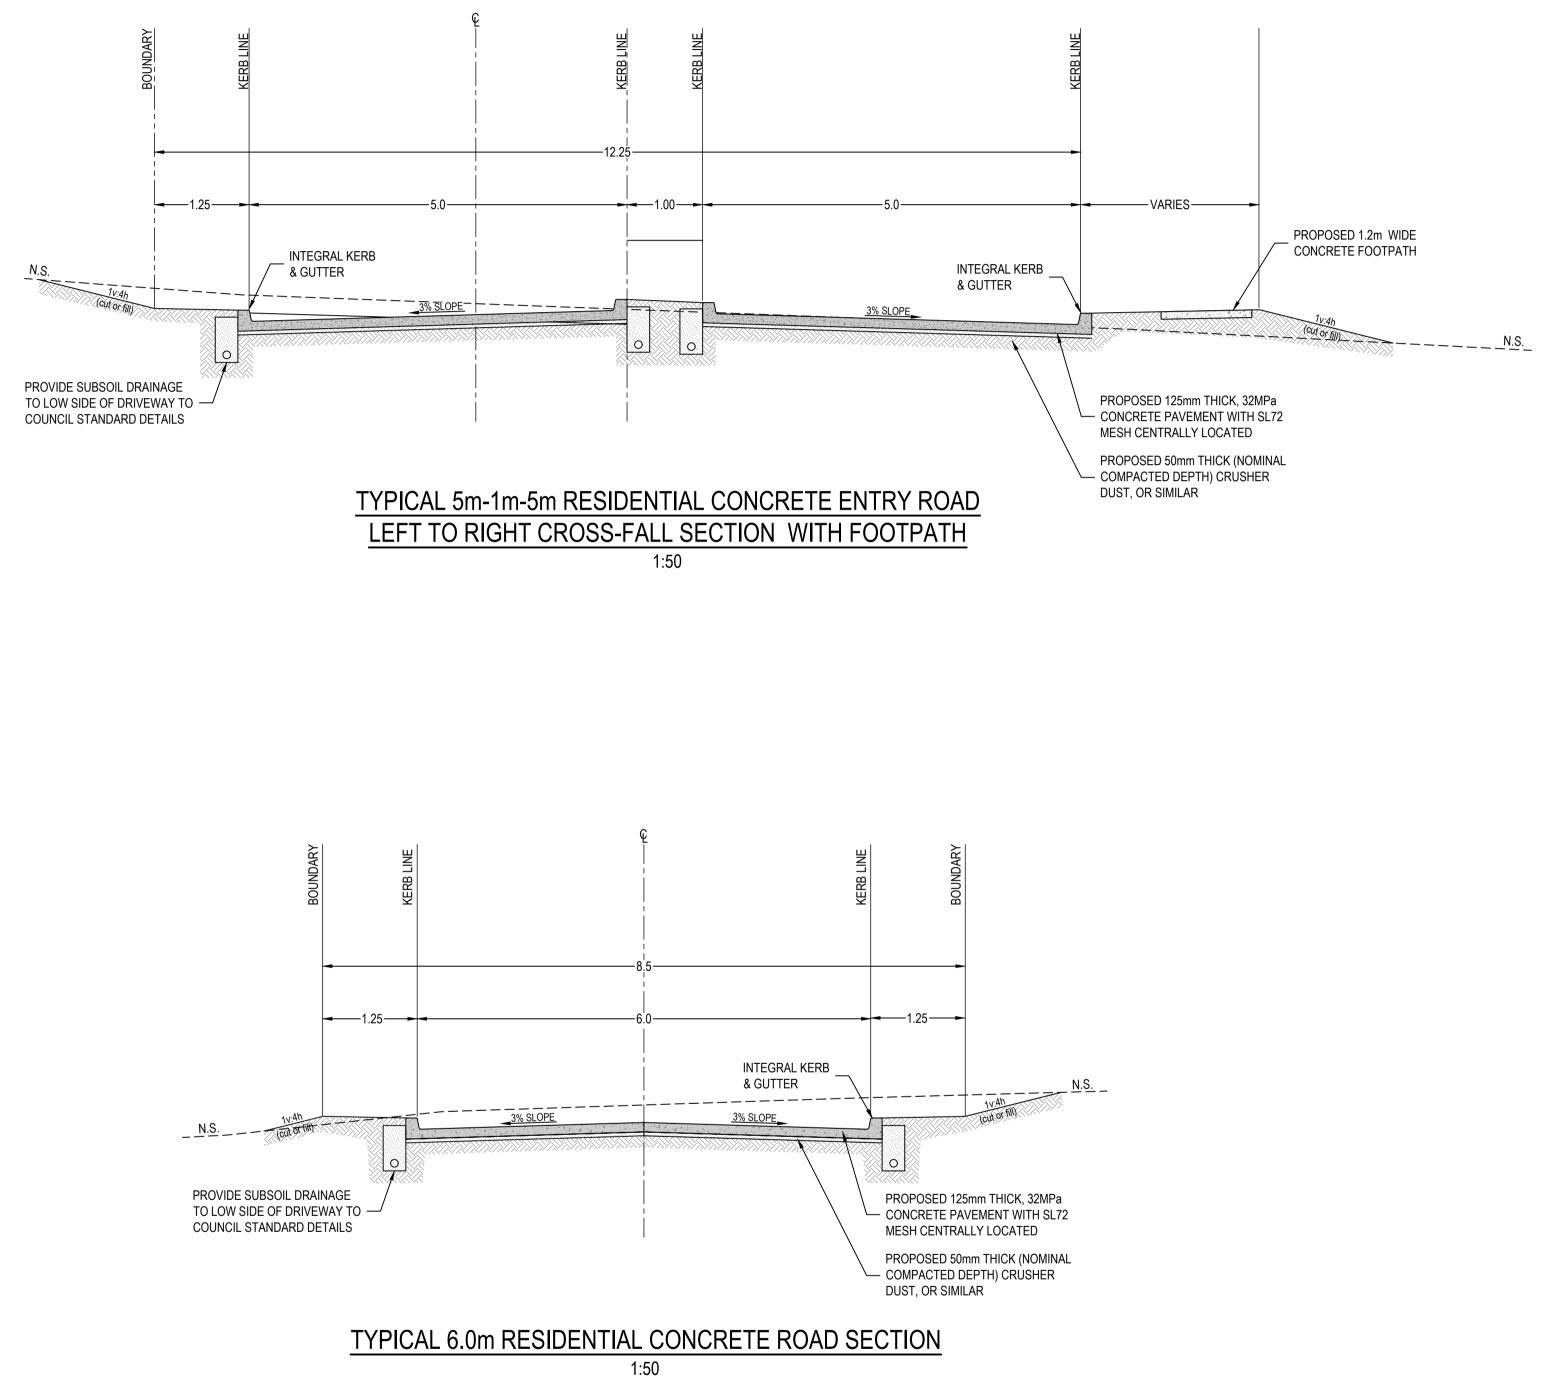

## WALLACE INFRASTRUCTURE CIVIL WORKS for DESIGN PTY LTD LOT 225 DP 246447

PART OF WALLACE DESIGN GROUP PTY LTD ABN: 96 154 894 952

PROJECT: LOT 225, DP 246447 34 WYNDELLA ROAD LOCHINVAR NSW 2321

CIVIL SITE

DRAWING TITLE: CIVIL SERVICES	DRAWING STA		DA APP	-	ION	٧					
SITE TYPICAL ROAD SECTIONS	SCALE:	1:5	0		ORIG. SIZE	DRIG. SIZE A1					
	DRAWN	DESIGNED	CHECKED	APPROVED	ENDORSED	DATE					
	MS	KB	AS	KB		01.05.25					
	PROJECT No.		DRAWING			REV					
	23128		C06.	.01		D					

### BASIN AND OUTLET CONTROL STRUCTURE NOTES:

TOTAL BASIN STORAGE


### WATER SURFACE LEVELS


20% AEP 5% AEP 1% AEP

OUT CONTROL STRUCTURE ORIFICE 1 & 2 WEIR 1 WEIR 2 EMERGENCY SPILLWAY 2290 m<sup>3</sup>

40.65 AHD 41.04 AHD 41.45 AHD

Ø350 AT 39.75 AHD 425mm AT 40.65 AHD 900X900 PIT AT 41.45 AHD 3m AT 41.50 AHD

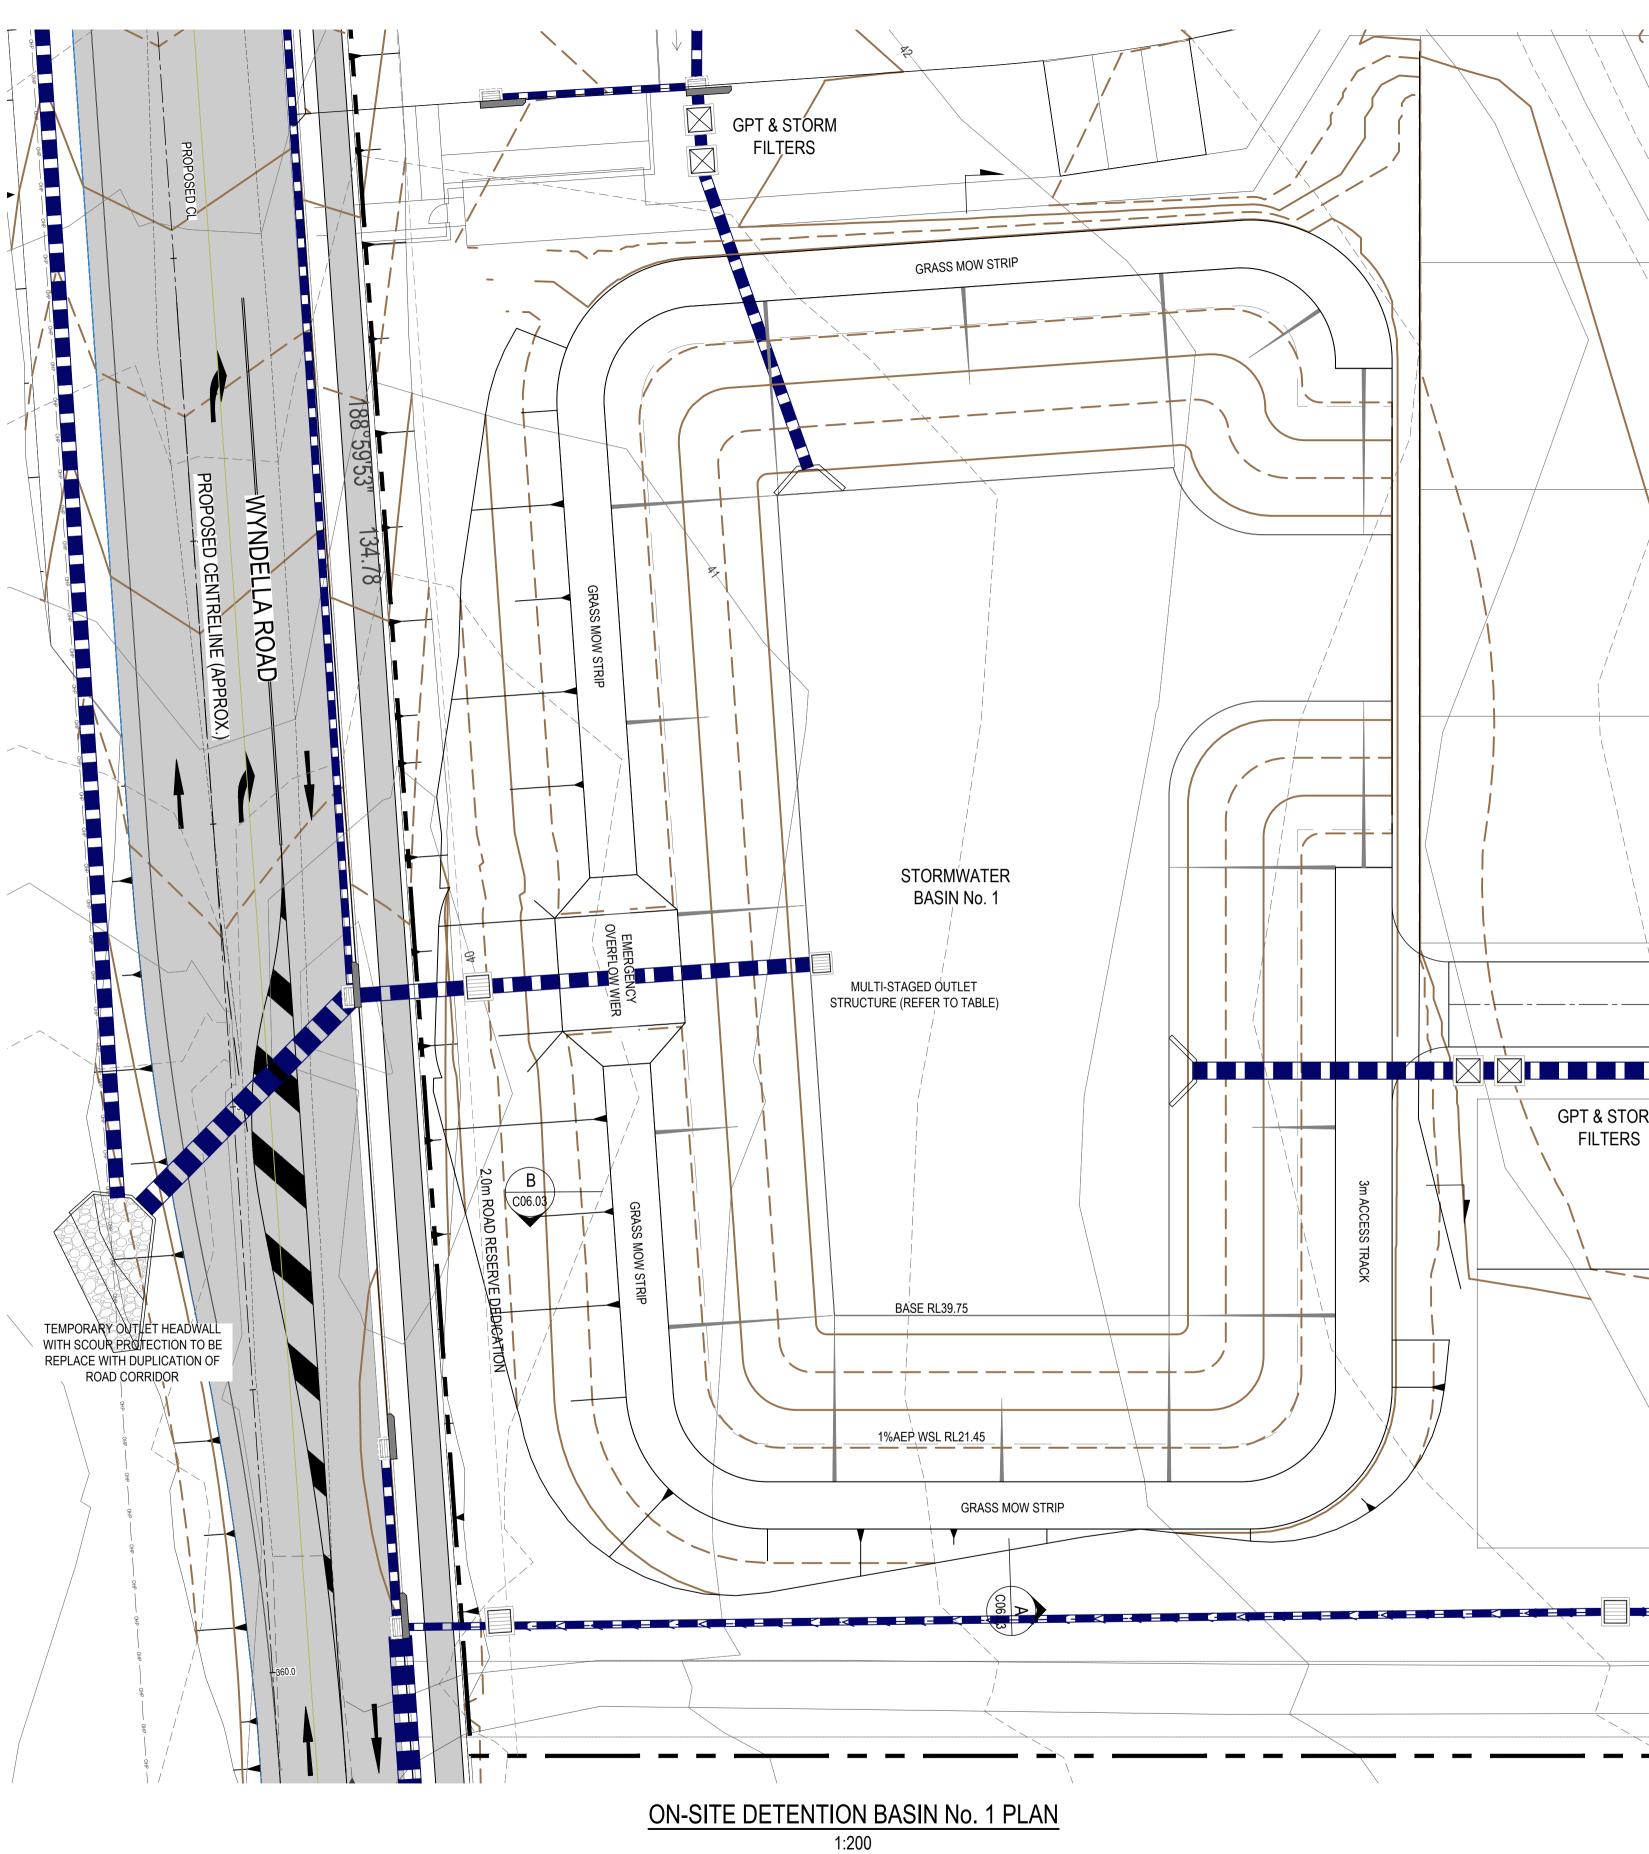

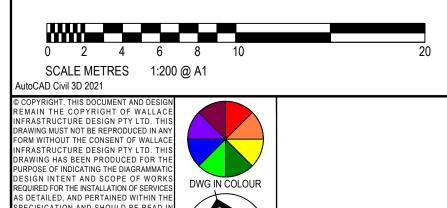

DWG IN COLOUR

PLOTTED BY:- KEN DATE:- 2 May 2025 3 34 PM FILENAME:- O:\PROJECTS\2023\23128 - 34 WYNDELLA ROAD, LOCHINVAR\CAD\TITLE\23128\_CIV\_DA-[E]\_34 WYNDELLA ROAD

AS DETAILED, AND PERTAINED WITHIN THE SPECIFICATION AND SHOULD BE READ IN CONJUNCTION WITH THE ARCHITECTURAL SPECIFICATION, ASSOCIATED SPECIFICATION, CODES AND STANDARDS. ALL DIMENSIONS, LEVELS AND EXISTING SERVICES SHALL BE INVESTIGATED AND SOLVED FOR DUCE DATION

STIGATED AND CONFIRMED ON SITE BY THE SUBCONTRACTOR AND BUILDER PRIOR TO THE COMMENCEMENT OF ANY WORKS.

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D	LEC AMENDMENTS	01.05.25	K.B.		E				
С	COUNCIL AMENDMENTS - S34 OUTCOMES	28.11.24	K.B.		i				
В	COUNCIL AMENDMENTS - PREL S34	19.08.24	K.B.		I				
А	ISSUED FOR DA APPROVAL	02.02.24	K.B.		(				
REV	DESCRIPTION	DATE	APPV'D	ENDO'D					

ARCHITECT: **BDA ARCHITECTS** PO Box 308 BROAD BEACH QLD 4218 info@bdaarch.com.au 07 5555 2600

CLIENT: Commercial 7 Pty Ltd ATF Commercial 7 Unit Trust PO Box 1138 HUNTERS HILL NSW 2110



### WALLACE INFRASTRUCTURE | CIVIL WORKS for **DESIGN PTY LTD**


PART OF WALLACE DESIGN GROUP PTY LTD ABN: 96 154 894 952 PO BOX 23, CHARLESTOWN, NSW 2290

PROJECT: LOT 225, DP 246447 34 WYNDELLA ROAD LOCHINVAR NSW 2321

CIVIL ON-S


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ng title: L SERVICES	DRAWING STA		DA APP	-	ION	
SITE DETENTION BASIN No.1 PLAN	SCALE:	1::	ORIG. SIZE			
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	PROJECT No.		DRAWING	No.		REV
	23128		C06.	.02		D

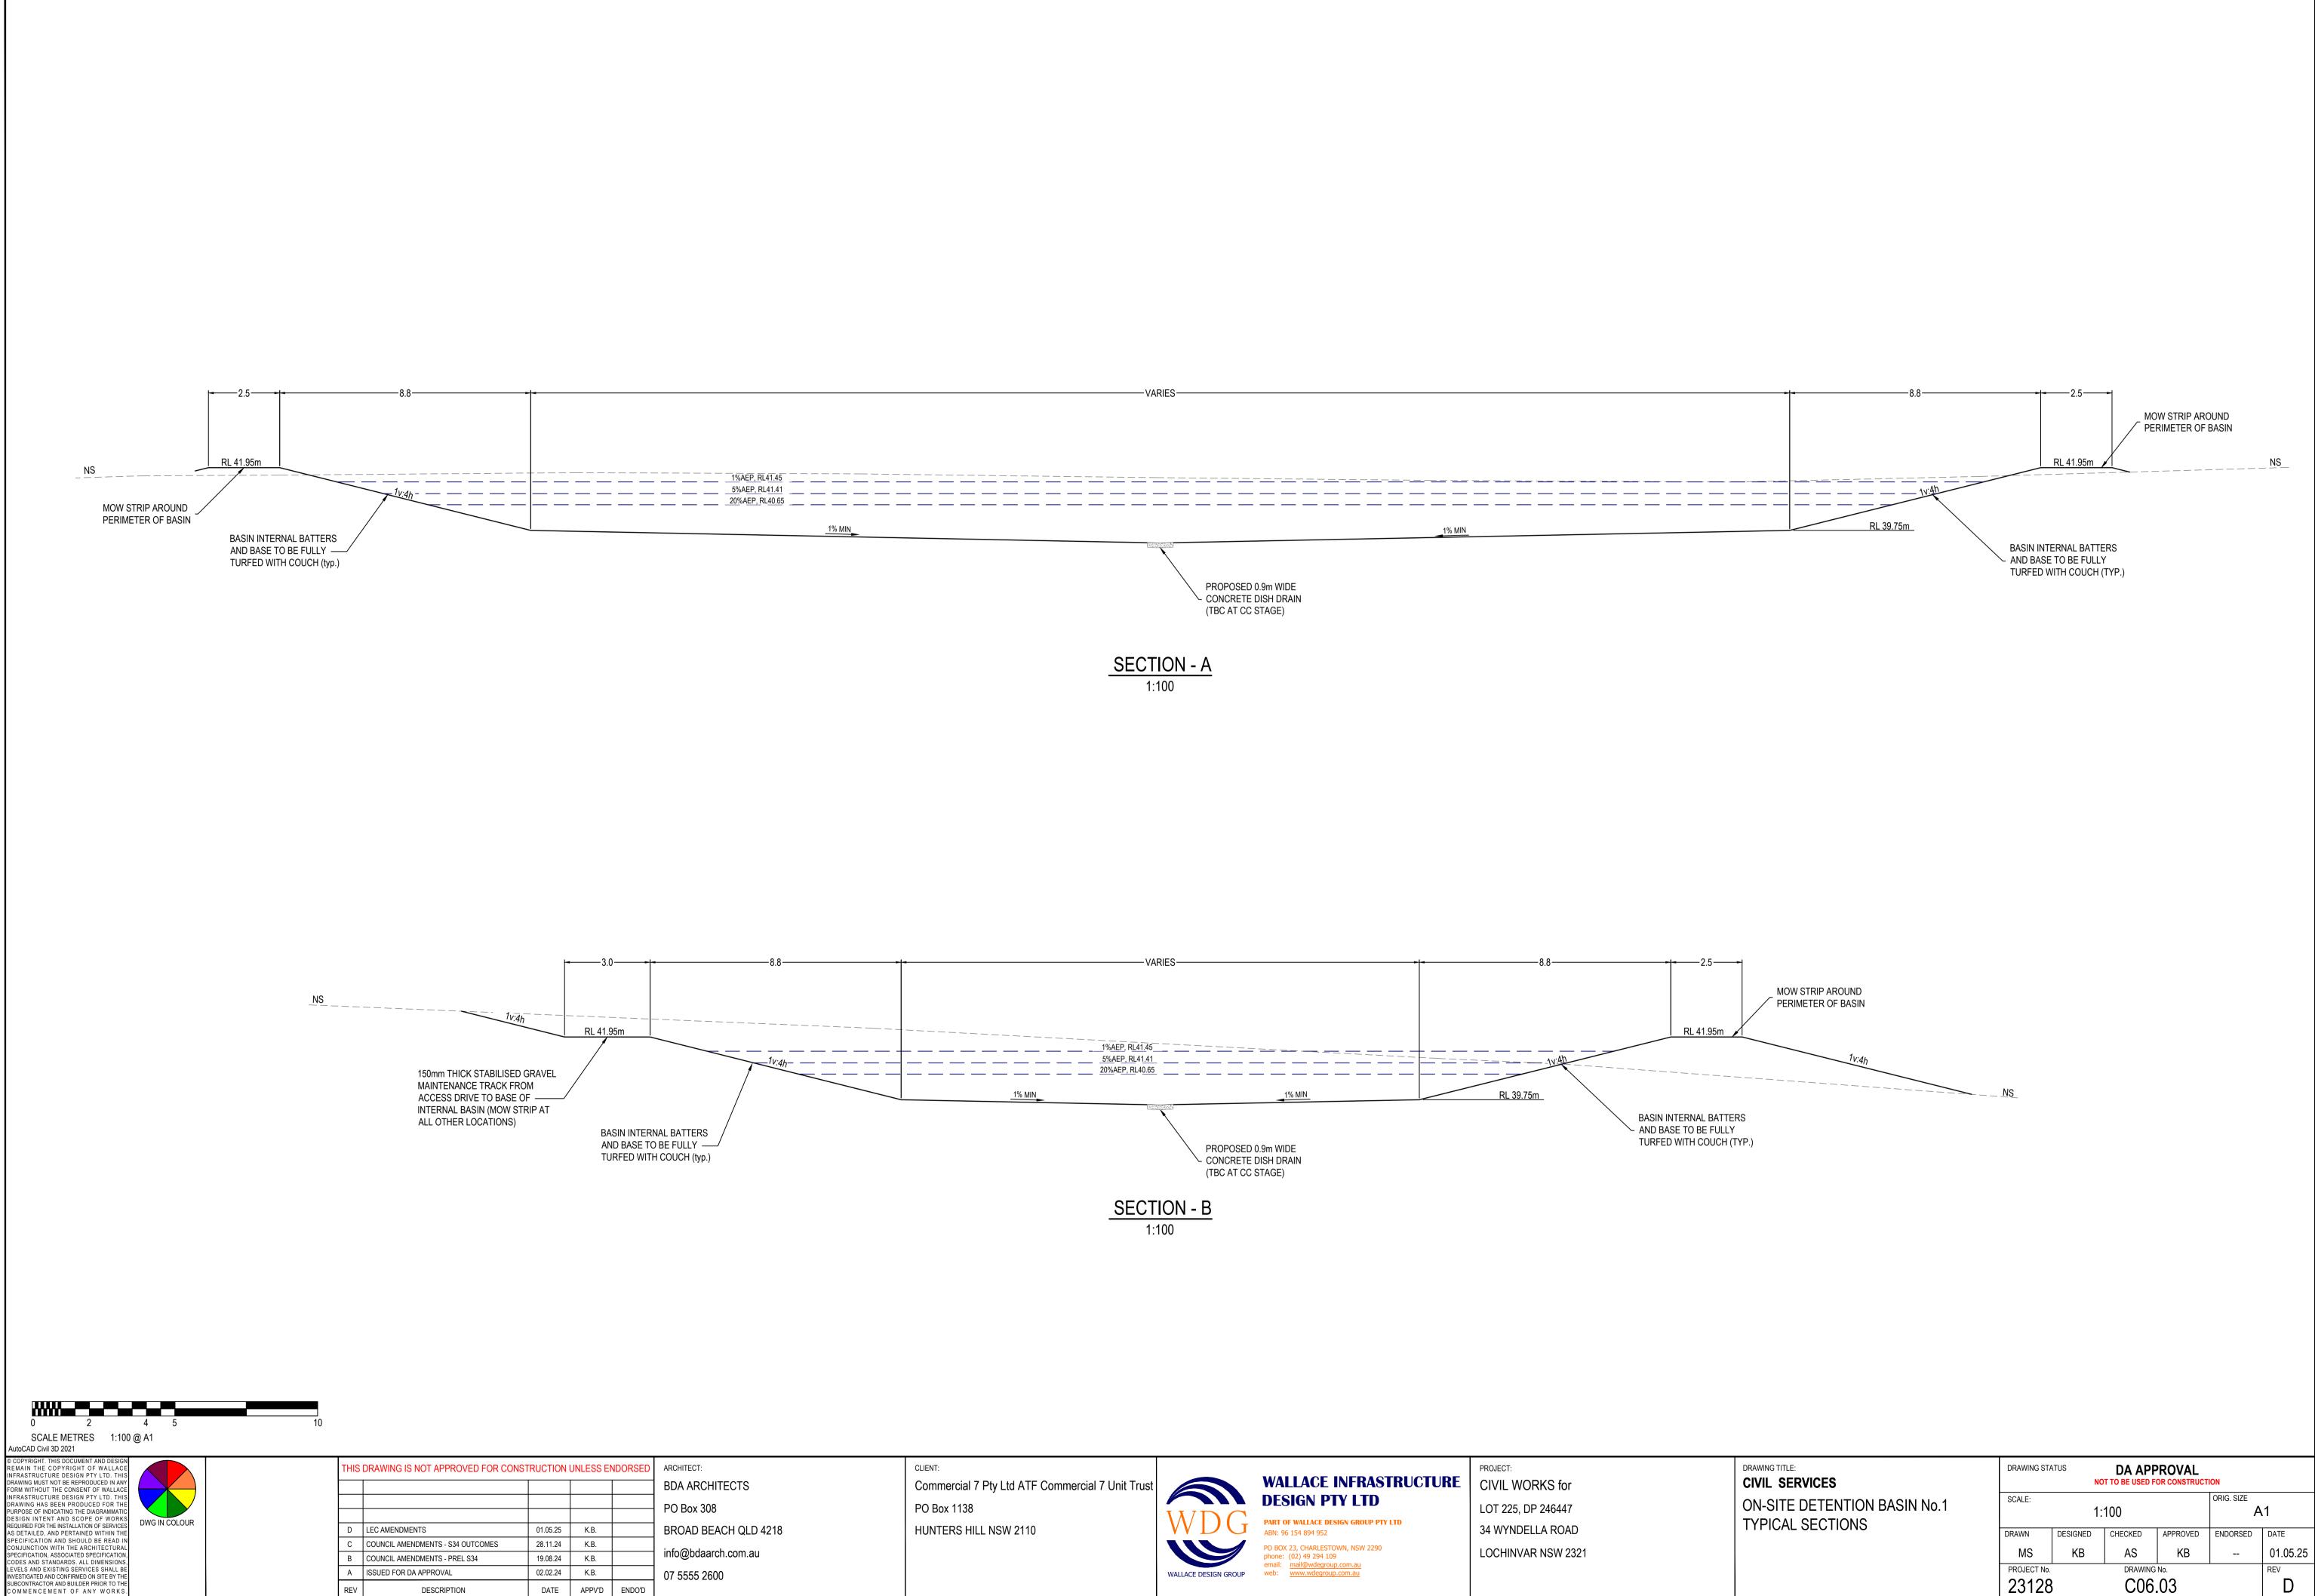


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PLOTTED BY:- KEN DATE:- 2 May 2025 3 34 PM FILENAME:- O:\PROJECTS\2023\23128 - 34 WYNDELLA ROAD, LOCHINVAR\CAD\TITLE\23128\_CIV\_DA-[E]\_34 WYNDELLA ROAD



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DESIGN INTENT AND SCOPE OF WORKS REQUIRED FOR THE INSTALLATION OF SERVICES AS DETAILED, AND PERTAINED WITHIN THE	DWG IN COLOUR		D	LEC AMENDMENTS	01.05.25	K.B.		BROAD
SPECIFICATION AND SHOULD BE READ IN CONJUNCTION WITH THE ARCHITECTURAL			С	COUNCIL AMENDMENTS - S34 OUTCOMES	28.11.24	K.B.		
SPECIFICATION, ASSOCIATED SPECIFICATION, CODES AND STANDARDS. ALL DIMENSIONS,			В	COUNCIL AMENDMENTS - PREL S34	19.08.24	K.B.		info@b
LEVELS AND EXISTING SERVICES SHALL BE INVESTIGATED AND CONFIRMED ON SITE BY THE			А	ISSUED FOR DA APPROVAL	02.02.24	K.B.		07 555
SUBCONTRACTOR AND BUILDER PRIOR TO THE COMMENCEMENT OF ANY WORKS.			REV	DESCRIPTION	DATE	APPV'D	ENDO'D	
PLOTTED BY:- KEN DATE:- 2 May 2	025 3 34 PM FILENA	- AME:- 0:\PROJECTS\2023\23128 - 34 WYND	ELLA RO	DAD, LOCHINVAR\CAD\TITLE\23128_CIV_DA-[E]_34	WYNDELLA RO	AD		

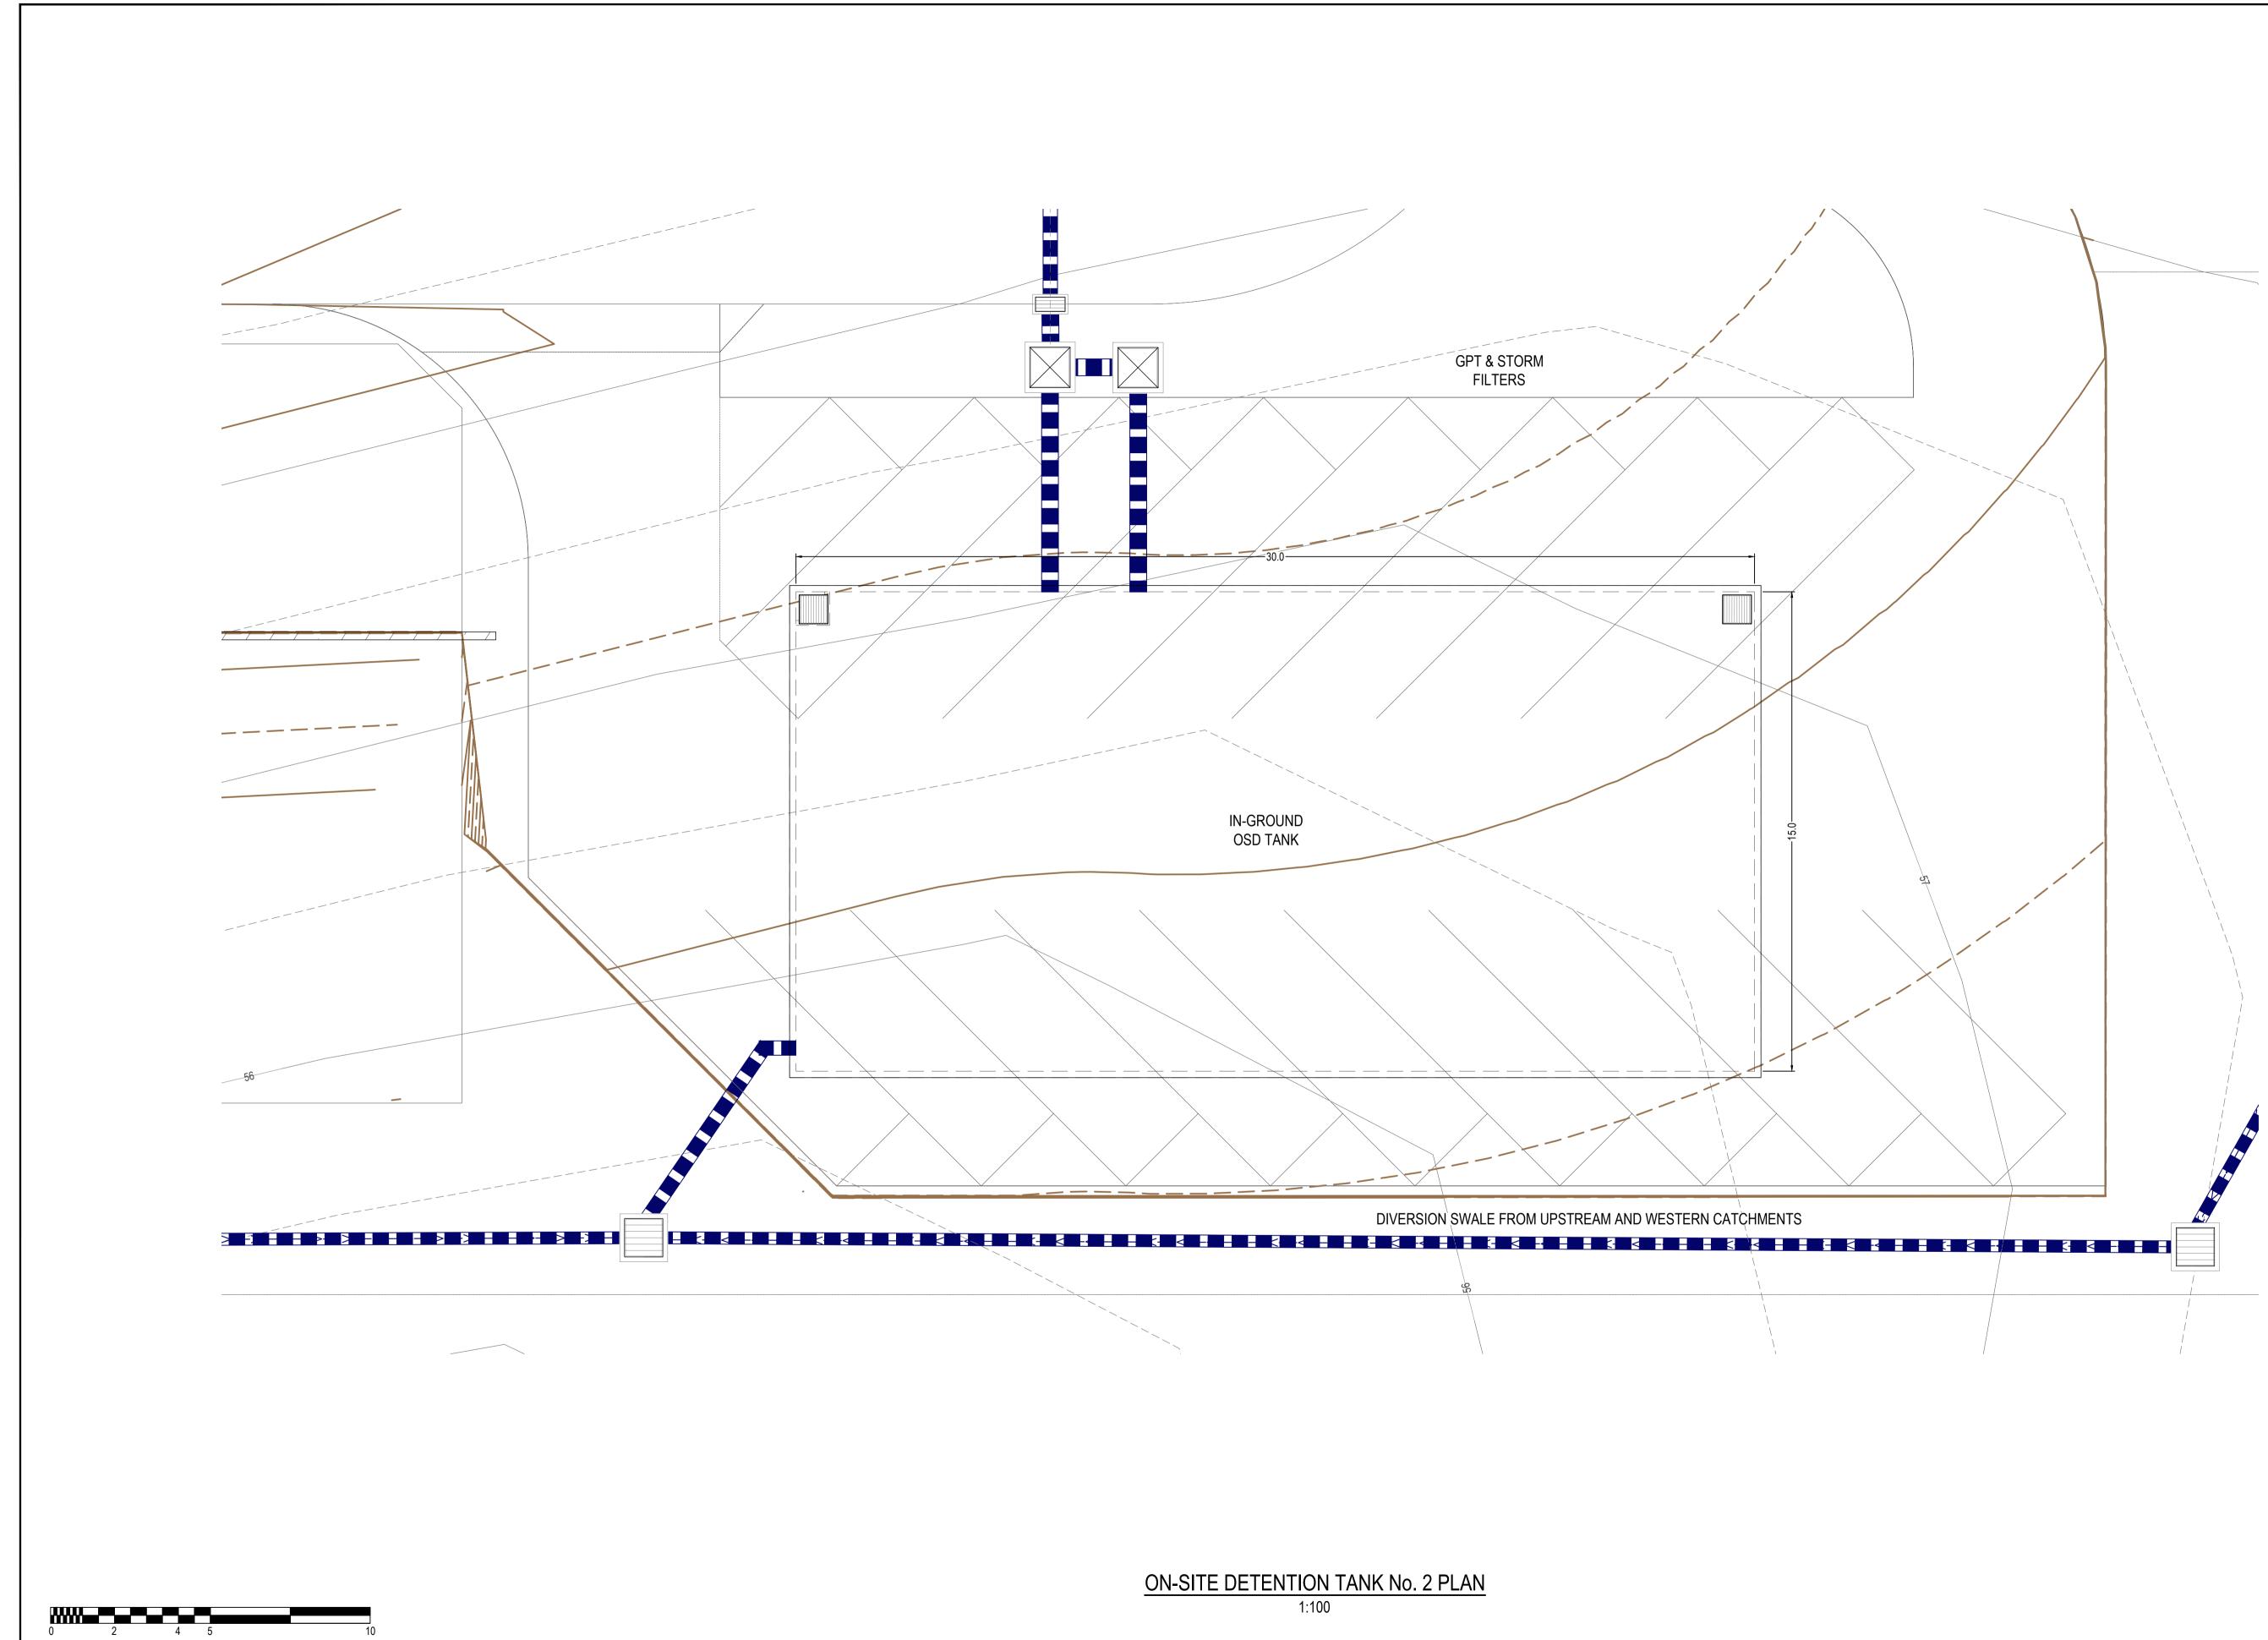CT: ARCHITECTS ox 308 AD BEACH QLD 4218 bdaarch.com.au 555 2600

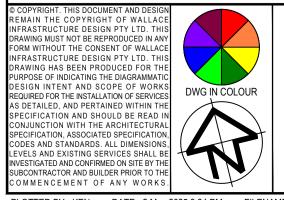CLIENT: Commercial 7 Pty Ltd ATF Commercial 7 Unit Trust PO Box 1138 HUNTERS HILL NSW 2110



## WALLACE INFRASTRUCTURE CIVIL WORKS for DESIGN PTY LTD LOT 225 DP 246447

PART OF WALLACE DESIGN GROUP PTY LTD ABN: 96 154 894 952


PROJECT: LOT 225, DP 246447 34 WYNDELLA ROAD LOCHINVAR NSW 2321


DRAWING TITLE: CIVIL SERVICES	DRAWING STA		DA APF	PROVAL	ION	
ON-SITE DETENTION TANK No. 2 PLAN	I SCALE: ORIG. SIZE A1		.1			
	DRAWN	DESIGNED	CHECKED	APPROVED	ENDORSED	DATE
	MS	KB	AS	KB		01.05.25
	PROJECT No. 23128		DRAWING		•	REV
			000	.04		U

### BASIN AND OUTLET CONTROL STRUCTURE NOTES: 1035 m<sup>3</sup> TOTAL BASIN STORAGE WATER SURFACE LEVELS 56.57 AHD 20% AEP 5% AEP 57.05 AHD 1% AEP 57.66 AHD OUT CONTROL STRUCTURE Ø250 AT 55.4 AHD **ORIFICE 1** Ø250 AT 56.6 AHD **ORIFICE 2** EMERGENCY OVERFLOW WEIR 1.8m AT 57.7 AHD OUTLET PIPE FROM TANK 450mm RCP 900x900 CLASS D TANK WALLS, SLAB & TOP SEALED ACCESS HATCH -TO STRUCTURAL ENGINEER -SL (TBC AT CC) DETAILS & SPECIFICATIONS) \_\_\_\_\_ PROVIDE STEP IRONS PER AS3500.3 AND AS1204 WHERE DEPTH EXCEEDS 1.2m. IL 55.4 ෆි 900x900 CLASS D

SEALED ACCESS HATCH – SL VARIES PER DESIGN \_\_\_\_ -PROVIDE STEP IRONS PER AS3500.3 AND AS1204 WHERE — DEPTH EXCEEDS 1.2m. -----`\_\_\_\_


IL 55.40

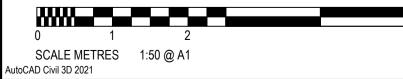

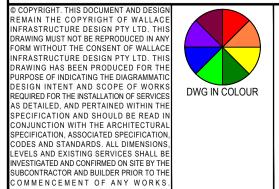

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INFRASTRUCTURE DESIGN PTY LTD. THIS DRAWING HAS BEEN PRODUCED FOR THE PURPOSE OF INDICATING THE DIAGRAMMATIC DESIGN INTENT AND SCOPE OF WORKS		-						PO Box 308	
REQUIRED FOR THE INSTALLATION OF SERVICES AS DETAILED, AND PERTAINED WITHIN THE	DWG IN COLOUR		D	LEC AMENDMENTS	01.05.25	K.B.		BROAD BEAG	
SPECIFICATION AND SHOULD BE READ IN CONJUNCTION WITH THE ARCHITECTURAL				С	COUNCIL AMENDMENTS - S34 OUTCOMES	28.11.24	K.B.		
SPECIFICATION, ASSOCIATED SPECIFICATION, CODES AND STANDARDS. ALL DIMENSIONS,			В	COUNCIL AMENDMENTS - PREL S34	19.08.24	K.B.		info@bdaarch	
LEVELS AND EXISTING SERVICES SHALL BE INVESTIGATED AND CONFIRMED ON SITE BY THE			А	ISSUED FOR DA APPROVAL	02.02.24	K.B.		07 5555 2600	
SUBCONTRACTOR AND BUILDER PRIOR TO THE COMMENCEMENT OF ANY WORKS.			REV	DESCRIPTION	DATE	APPV'D	ENDO'D		
PLOTTED BY:- KEN DATE:- 2 May 20	PLOTTED BY:- KEN DATE:- 2 May 2025 3 34 PM FILENAME:- O:\PROJECTS\2023\23128 - 34 WYNDELLA ROAD, LOCHINVAR\CAD\TITLE\23128_CIV_DA-[E]_34 WYNDELLA ROAD								

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SECTION B

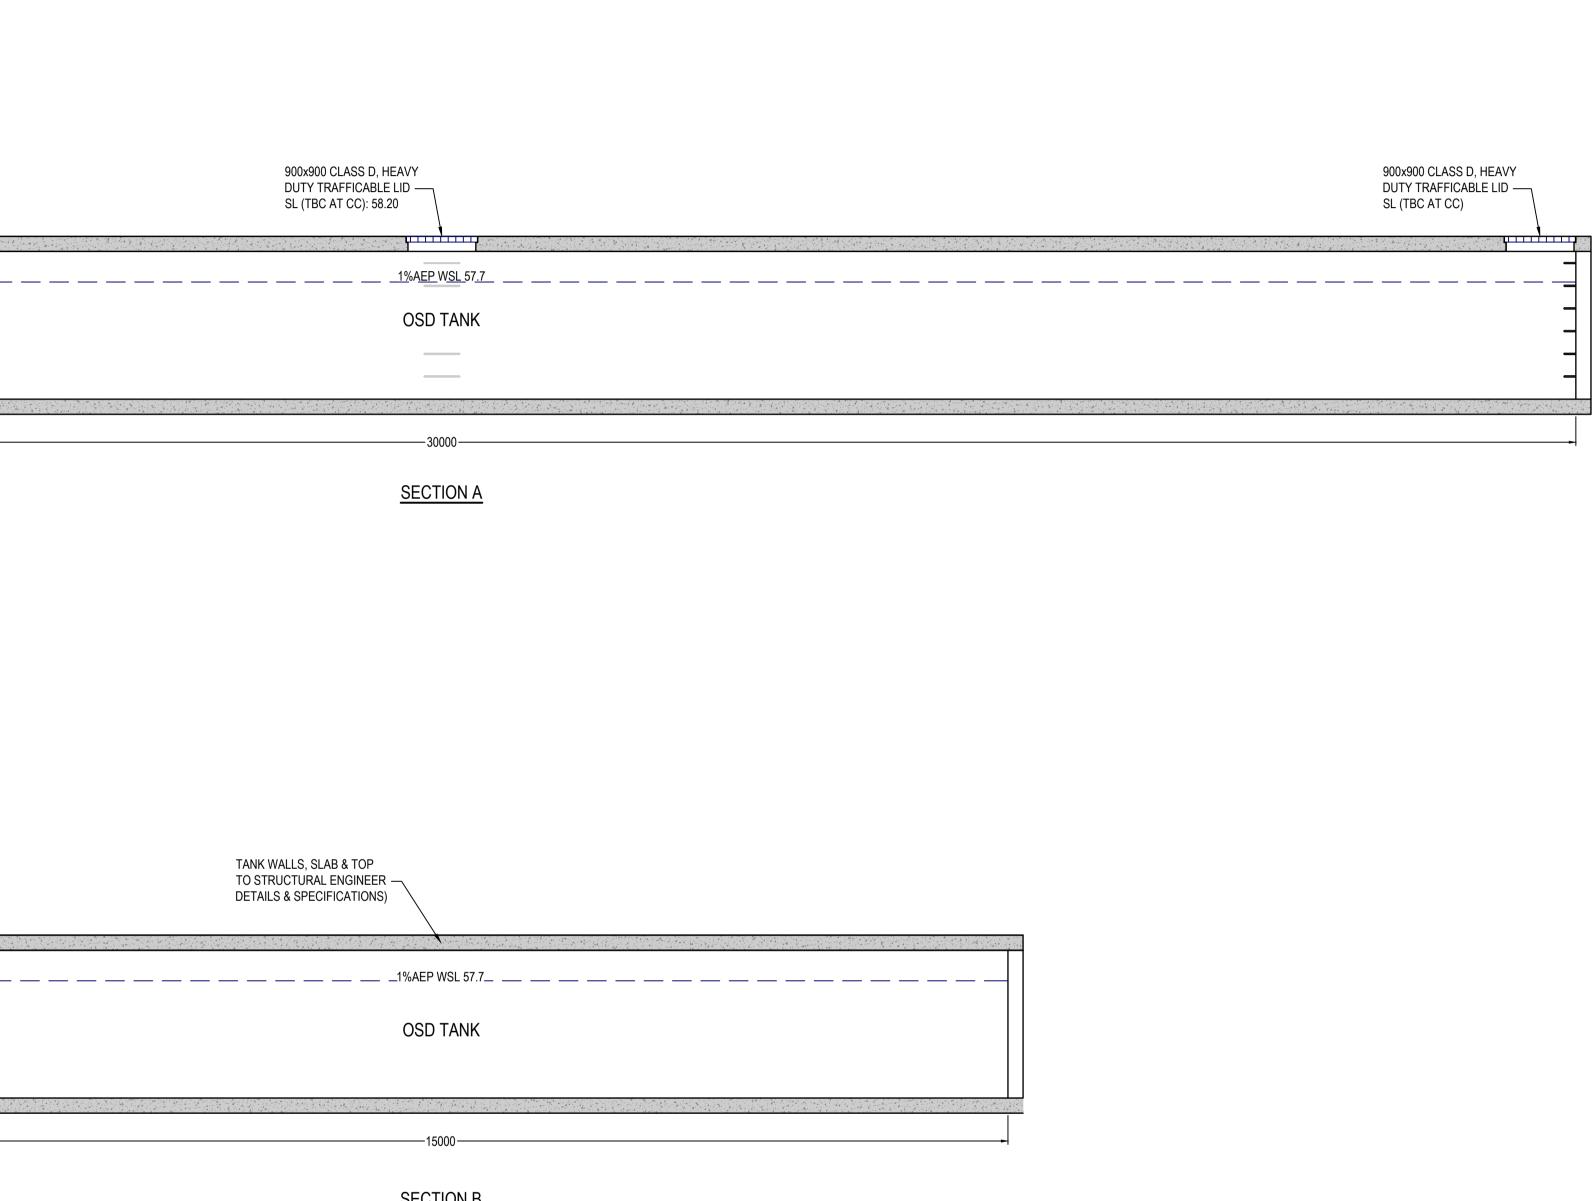

### WALLACE INFRASTRUCTURE CIVIL WORKS for **DESIGN PTY LTD**

PART OF WALLACE DESIGN GROUP PTY LTD ABN: 96 154 894 952

PROJECT: LOT 225, DP 246447 34 WYNDELLA ROAD LOCHINVAR NSW 2321

DRAWING TITLE: CIVIL SERVICES	DRAWING STATUS DA APPROVAL NOT TO BE USED FOR CONSTRUCTION						
ON-SITE DETENTION TANK No. 2 TYPICAL SECTIONS	SCALE: ORIG. S					RIG. SIZE A1	
	DRAWN	DESIGNED	CHECKED	APPROVED	ENDORSED	DATE	
	MS	KB	AS	KB		01.05.25	
	PROJECT No.		DRAWING	No.		REV	
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