



Sydney | Perth | Newcastle | Central Coast

Suite 2 Ground Floor 47 Darby Street Cooks Hill NSW 2300 T: +61 2 49419900 E: mail@lindsaydynan.com.au

PROJECT

MAITLAND CITY COUNCIL
ADMINISTRATION BUILDING

CLIENT

MAITLAND CITY COUNCIL

### **CIVIL DRAWING LIST**

DA-0001 GENERAL ARRANGEMENT PLAN & DRAWING LIST

DA-0002 SOIL & WATER MANAGEMENT PLAN & DETAILS

DA-0003 STORMWATER DRAINAGE PLAN - SHEET 1

DA-0004 STORMWATER DRAINAGE PLAN - SHEET 2

DA-0005 STORMWATER DRAINAGE PLAN - SHEET 3

DA-0006 STORMWATER DRAINAGE PLAN - SHEET 4
DA-0007 STORMWATER DRAINAGE PLAN - SHEET 5

DA-0008 STORMWATER DRAINAGE PLAN - SHEET 6

DA-0009 STORMWATER DRAINAGE PLAN - SHEET 7

DA-0010 STORMWATER DRAINAGE PLAN - SHEET 8
DA-0011 STORMWATER DRAINAGE PLAN - SHEET 9

DA-0012 STORMWATER DRAINAGE DETAILS

DA-0020 EXTERNAL WORKS PLAN

STORMWATER DRAINAGE PLAN - SHEET 1 STORMWATER DRAINAGE PLAN - SHEET 3 STORMWATER DRAINAGE PLAN - SHEET 2 14676-DA-0003 SCALE 1:100 14676-DA-0004 SCALE 1:100 14676-DA-0005 SCALE 1:100 EXTERNAL WORKS PLAN - PART B 14676-DA-0020 SCALE 1:100 STORMWATER DRAINAGE PLAN - SHEET 6 STORMWATER DRAINAGE PLAN - SHEET 4 STORMWATER DRAINAGE PLAN - SHEET 5 14676-DA-0006 SCALE 1:100 + 14676-DA-0008 SCALE 1:100 14676-DA-0007 SCALE 1:100 STORMWATER DRAINAGE PLAN - SHEET 7 14676-DA-0009 SCALE 1:100 EXTERNAL WORKS PLAN - PART A 14676-DA-0020 SCALE 1:100

 B
 26/03/19
 ISSUED FOR DA APPROVAL
 A.V. A.T.

 A
 21/03/19
 ISSUED FOR INFORMATION
 A.V. A.T.

 REV
 DATE
 DRAWING STATUS
 DRN APP

 TITLE


# GENERAL ARRANGEMENT PLAN & DRAWING LIST

DRAWING STATUS		SHEET SIZE	
FOR APP	A1		
DRAWN	DESIGNED	APPROVED	SCALE
A.Vizl	A.Thompson	B.Rodgers	1:500
PROJECT No.		DRAWING No.	REVISION

GENERAL ARRANGEMENT PLAN

SCALE 1:500


NOT FOR CONSTRUCTION 14676

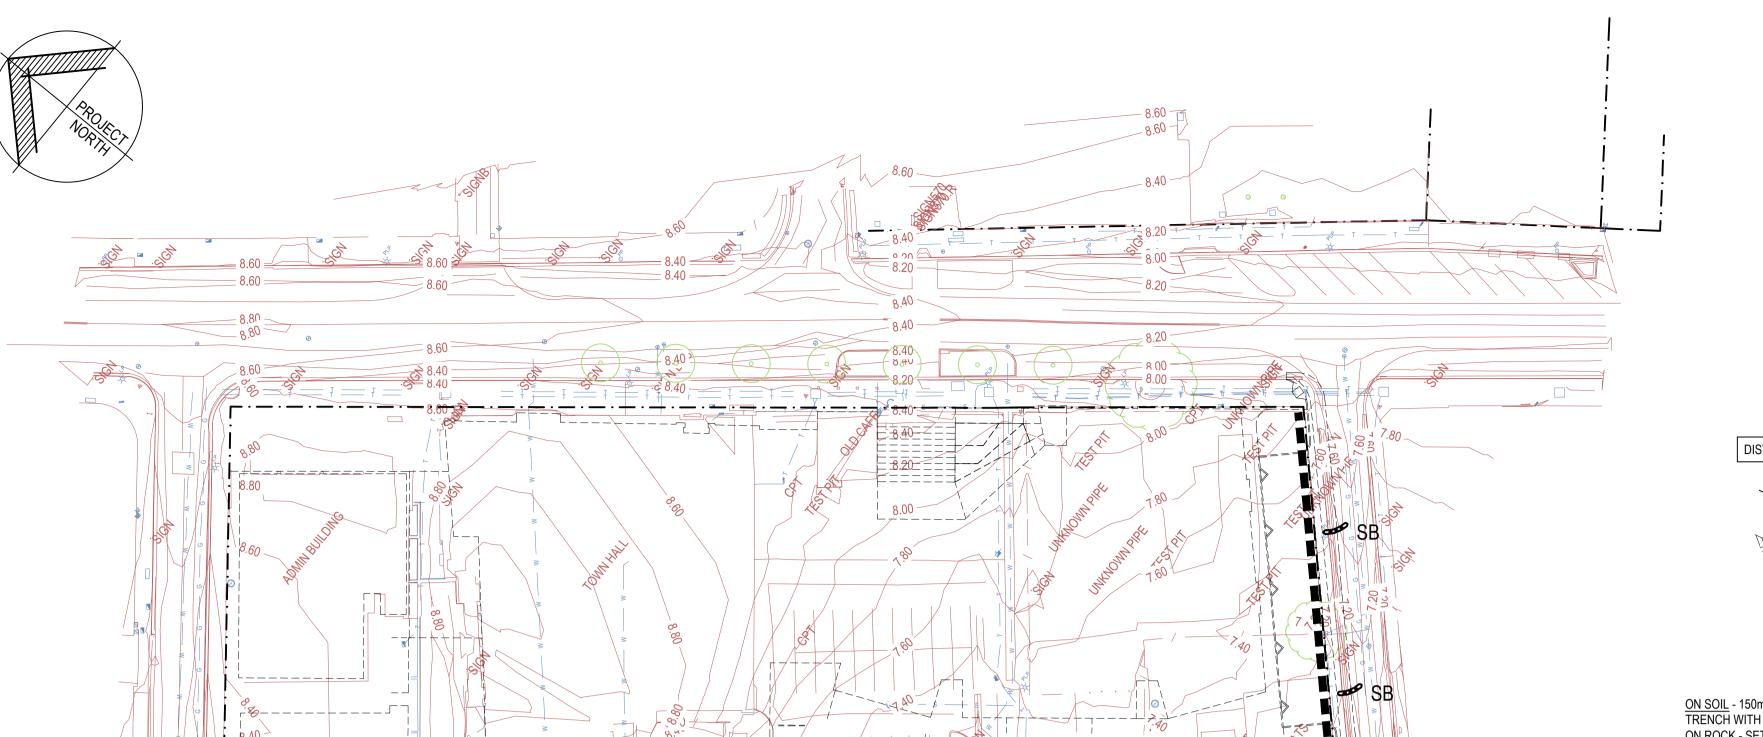

- STAR PICKETS, REFER BELOW PLAN VIEW 1.5m STAR PICKETS AT 2.50m — MAXIMUM CTS, EMBED 600mm INTO GROUND. PROVIDE SAFETY CAPS. DISTURBED AREA UNDISTURBED AREA - SELF-SUPPORTING GEOTEXTILE FILTER FABRIC ATTACHED TO STAR PICKETS ON SOIL - 150mm DEEP x 100mm WIDE TRENCH WITH COMPACTED BACKFILL ON ROCK - SET INTO SURFACE WITH MASS CONCRETE

# SEDIMENT CONTROL FENCE DETAIL


IN ACCORDANCE WITH LANDCOM 'BLUE BOOK' SD6-8 SEDIMENT FENCE

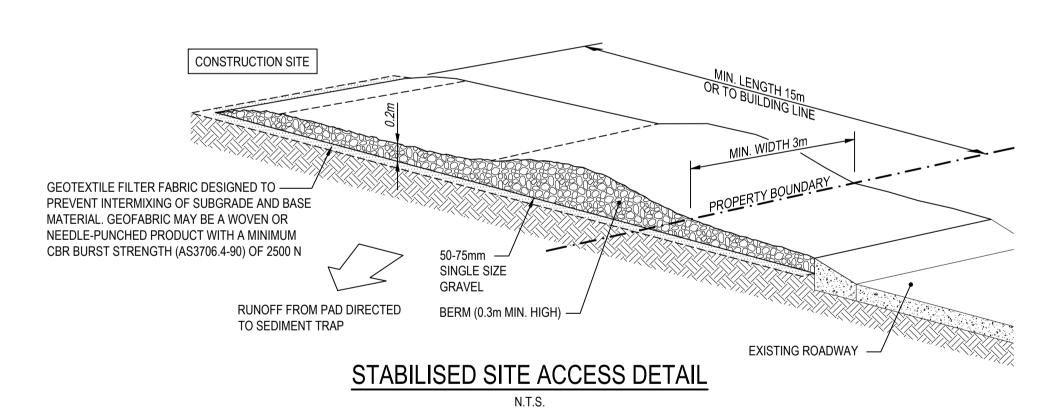

IN ACCORDANCE WITH LANDCOM 'BLUE BOOK'

SD6-14 STABILISED SITE ACCESS

SOIL & WATER MANAGEMENT PLAN SCALE 1:500

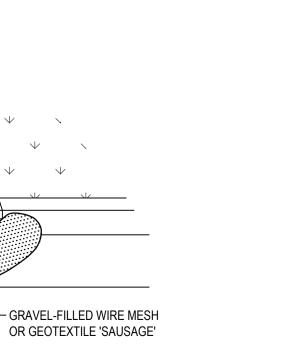


SAUSAGE INLET SEDIMENT TRAP DETAIL - SG

KERB INLET PIT


TIMBER SPACER —

TO SUIT

IN ACCORDANCE WITH LANDCOM 'BLUE BOOK' SD6-11 MESH AND GRAVEL INLET FILTER

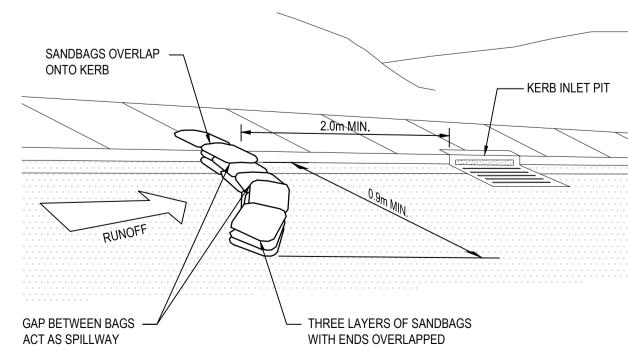

SANDBAG INLET SEDIMENT TRAP DETAIL - SB

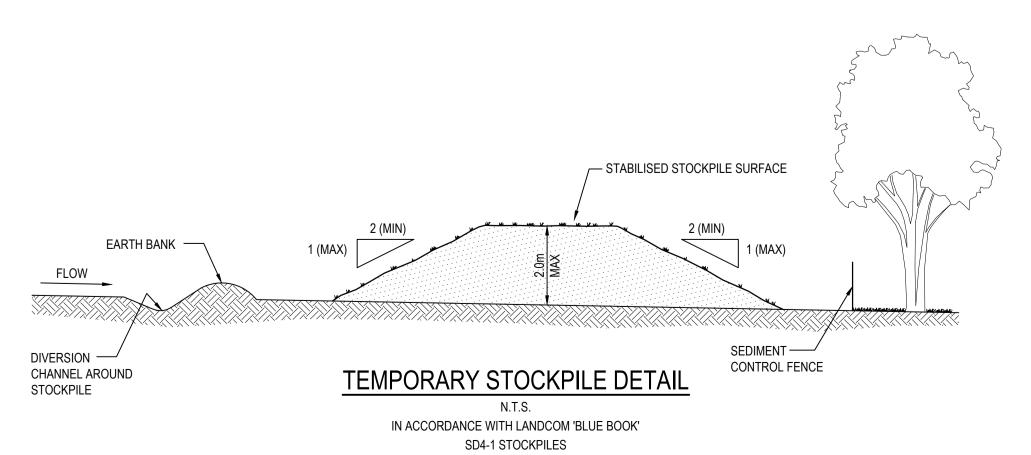

NOT FOR CONSTRUCTION



Sydney | Perth | Newcastle | Central Coast

Suite 2 Ground Floor 47 Darby Street Cooks Hill NSW 2300 T: +61 2 49419900 E: mail@lindsaydynan.com.au

PROJECT

MAITLAND CITY COUNCIL ADMINISTRATION BUILDING

MAITLAND CITY COUNCIL

**LEGEND** 

SEDIMENT CONTROL FENCE,

REFER TO DETAIL

STABILISED SITE ACCESS, REFER TO DETAIL

SANDBAG INLET SEDIMENT TRAP, REFER TO DETAIL

SAUSAGE INLET SEDIMENT TRAP, → SG REFER TO DETAIL

TEMPORARY STOCKPILE,

REFER TO DETAIL

EXISTING ELECTRICAL SERVICE EXISTING GAS SERVICE

EXISTING SEWER SERVICE

EXISTING TELSTRA SERVICE

EXISTING WATER SERVICE

**BOUNDARY LINE** 

EXISTING FENCE

EXISTING TREE

### NOTES

THE ARRANGEMENT OF SOIL & WATER MANAGEMENT MEASURES SHOWN ARE INDICATIVE ONLY AND RELATE TO A PARTICULAR STAGE OF THE CONSTRUCTION WORKS. IT SHALL BE THE CONTRACTOR'S RESPONSIBILITY TO DESIGN, CONSTRUCT AND MAINTAIN ANY ADDITIONAL MEASURES THAT MAY BE REQUIRED FOR THE CONTRACTOR'S CONSTRUCTION METHODOLOGIES. IN ORDER TO MEET ALL CONDITIONS AND REQUIREMENTS IMPOSED BY ANY STATUTORY AUTHORITY.

THE POSITION OF ALL EXISTING SERVICES SHOWN SHOULD BE REGARDED AS APPROXIMATE AND NOT NECESSARILY COMPREHENSIVE. IT IS THE CONTRACTOR'S RESPONSIBILITY TO DETERMINE THE EXACT LOCATIONS OF ALL SERVICES WHETHER SHOWN ON THE DRAWING OR NOT AND INFORM ALL RELEVANT AUTHORITIES PRIOR TO ANY EXCAVATION.

CONTRACTOR TO VERIFY SETOUT BEFORE COMMENCING EARTHWORKS. REFER ANY DISCREPANCIES TO ENGINEER.

ALL EXPOSED/DISTURBED AREAS TO BE TREATED IN ACCORDANCE WITH ARCHITECTS REQUIREMENTS.


EXISTING CONTOURS ARE SHOWN AT 0.20m INTERVALS.


A 26/03/19 ISSUED FOR DA APPROVAL DRN APP REV DATE DRAWING STATUS

## **SOIL & WATER MANAGEMENT** PLAN & DETAILS

DRAWING STATUS SHEET SIZE FOR APPROVAL **A**1 DRAWN SCALE A.Thompson A.Vizl 1:500 B.Rodgers PROJECT No. REVISION DRAWING No.

14676 DO NOT SCALE - THIS DRAWING MAY BE A REDUCED COPY

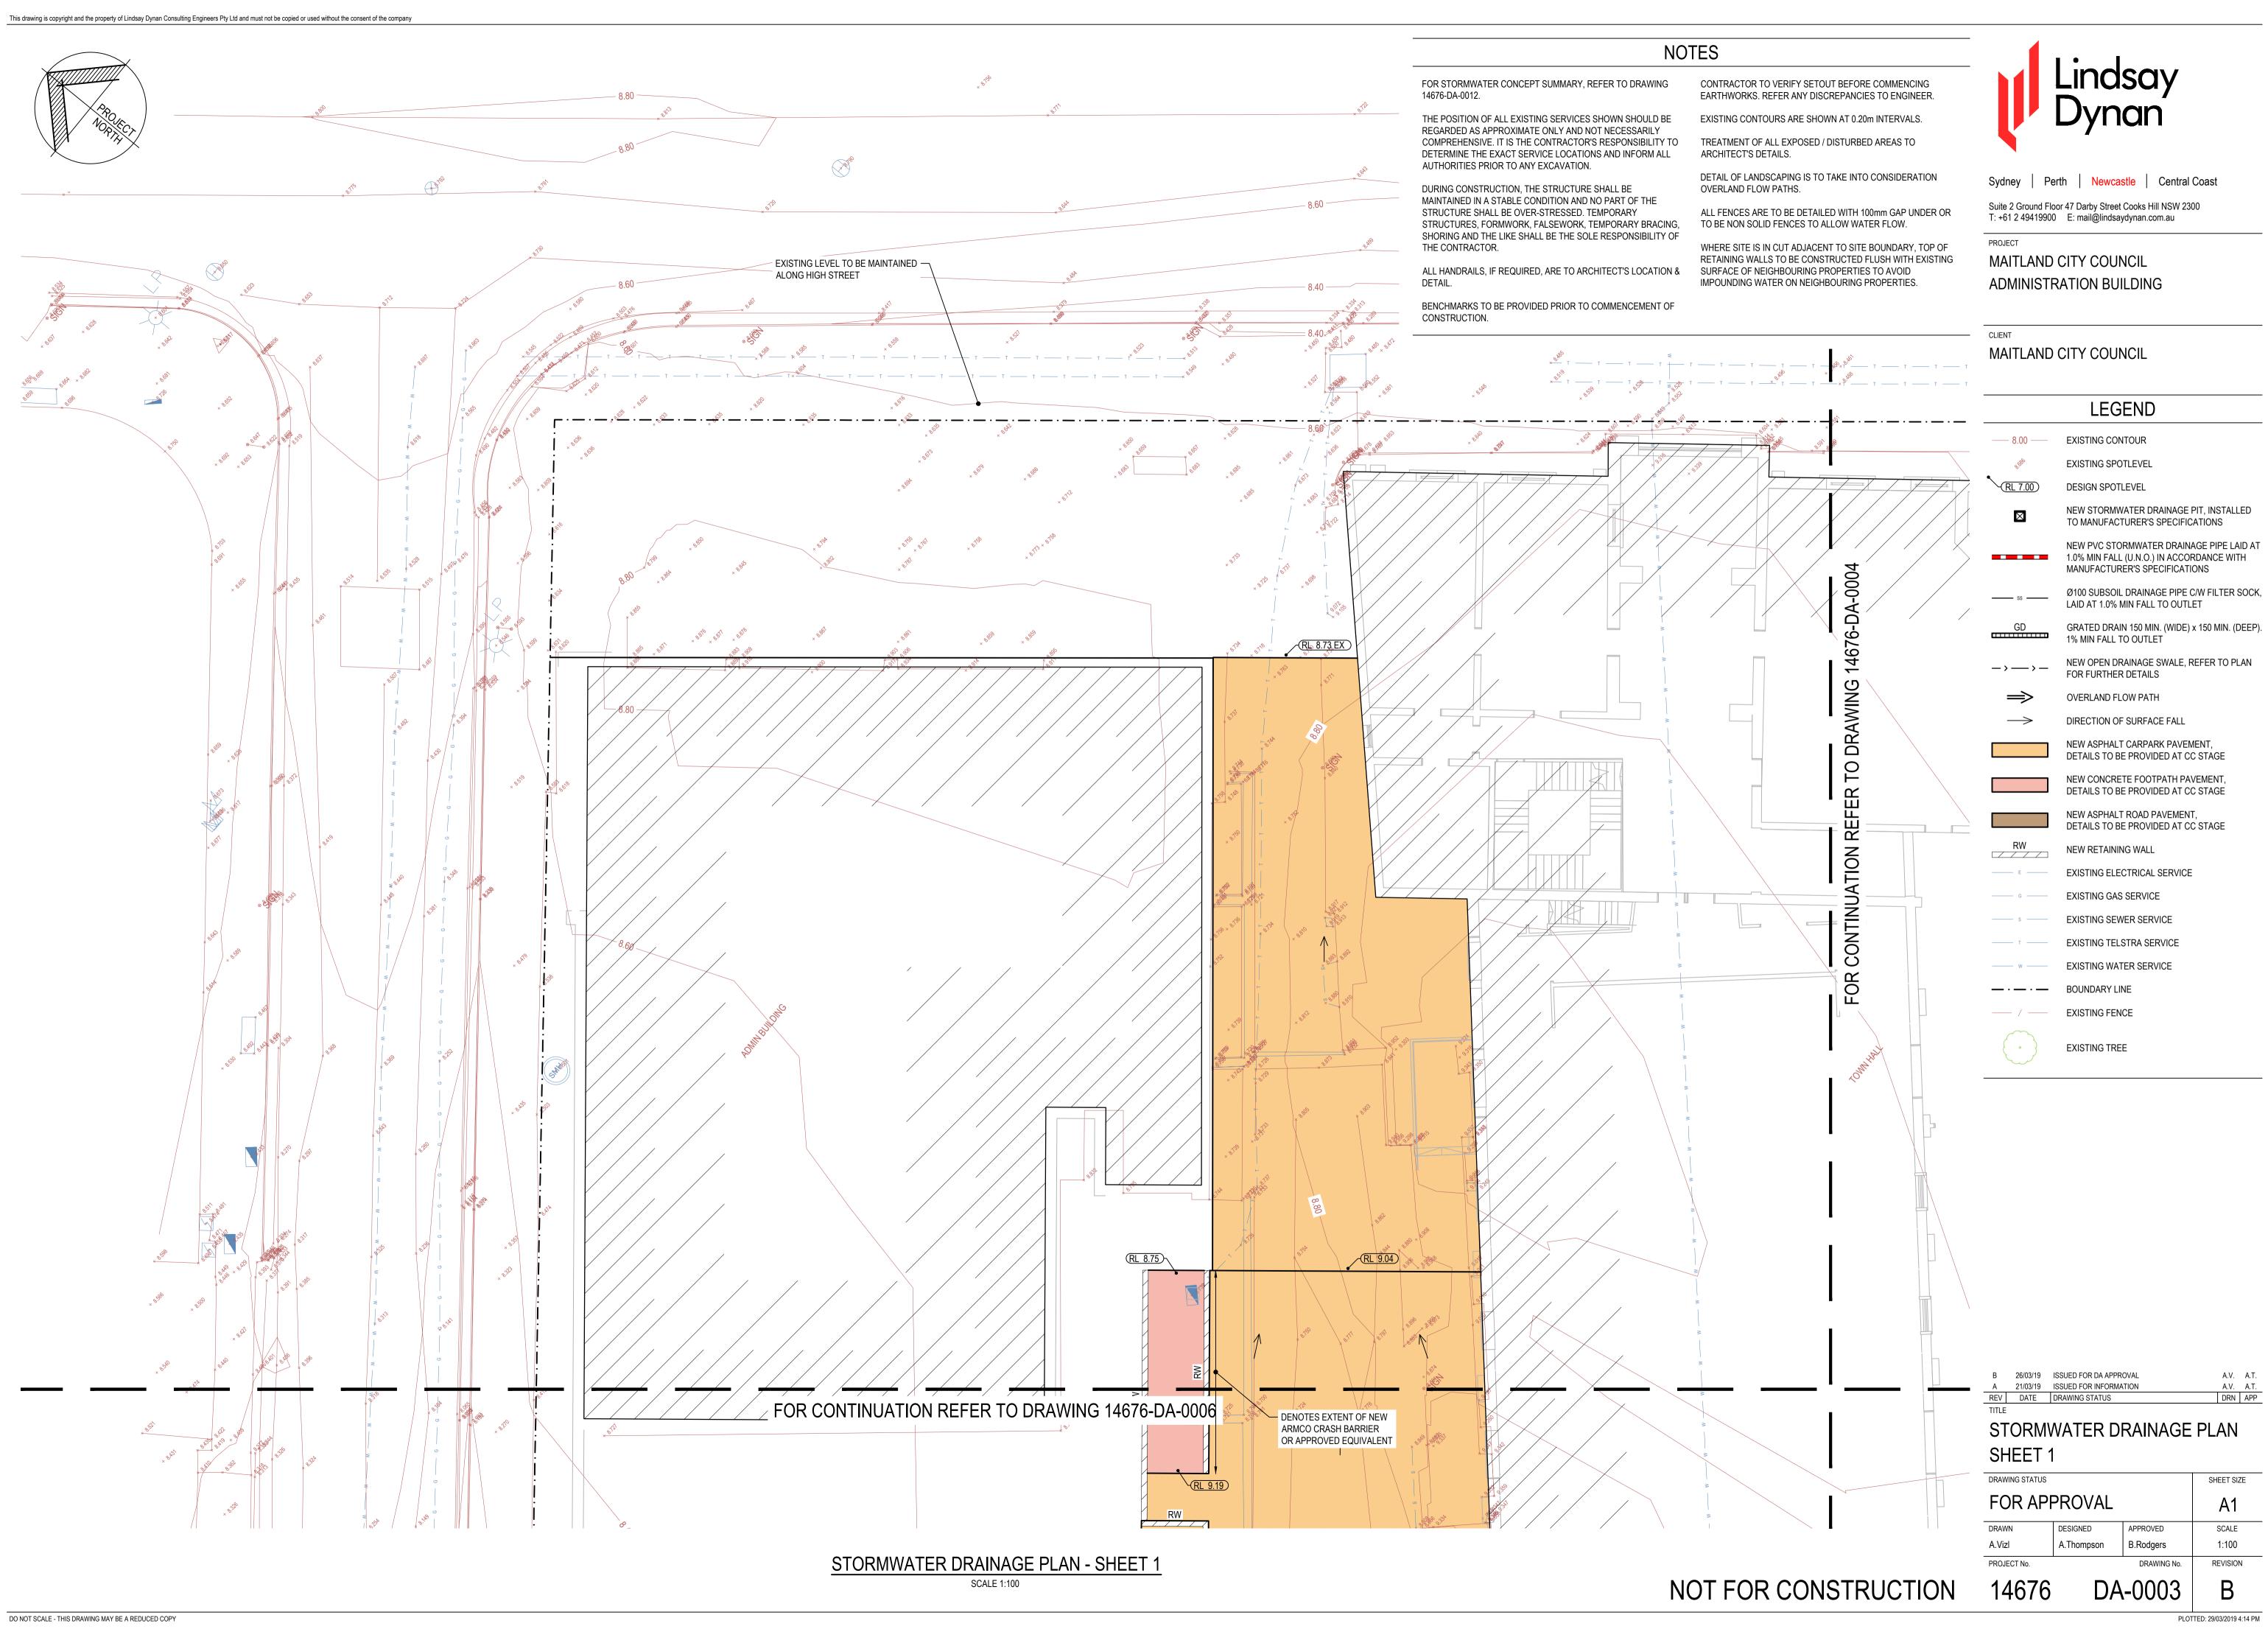

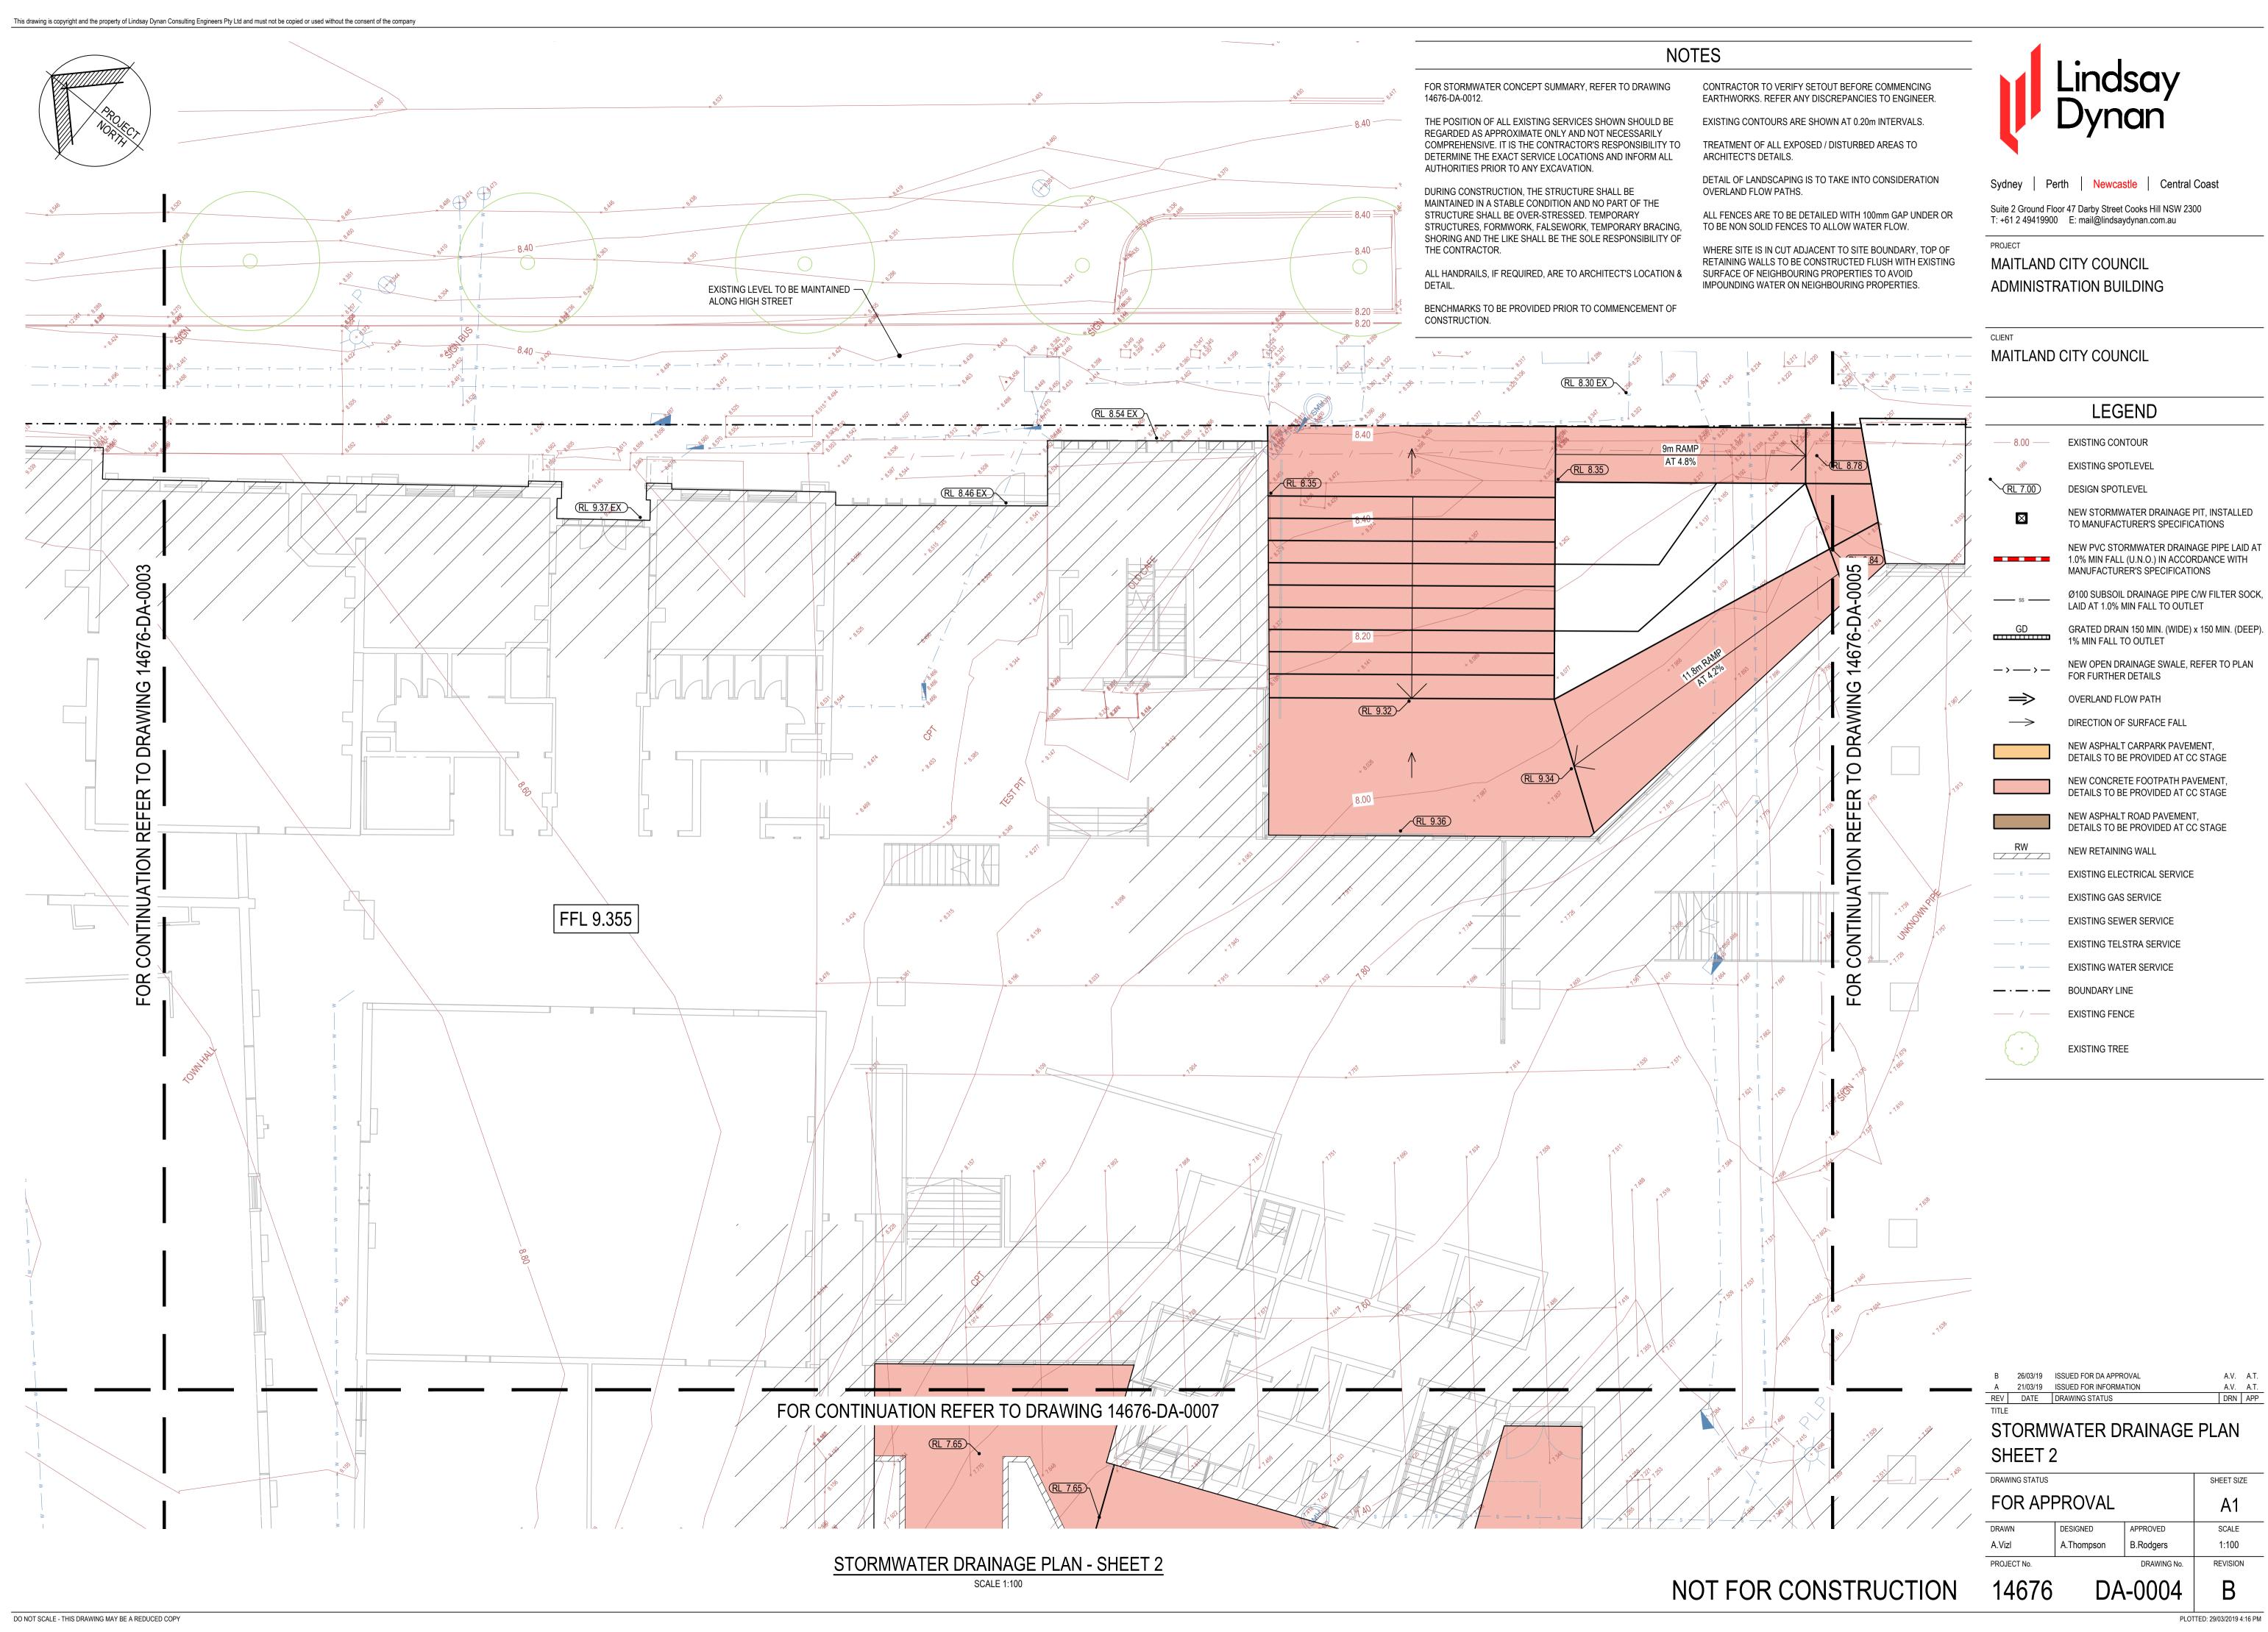

STORMWATER DRAINAGE PLAN - SHEET 3

SCALE 1:100

Lindsa Dynan

Sydney | Perth | Newcastle | Central Coast

Suite 2 Ground Floor 47 Darby Street Cooks Hill NSW 2300 T: +61 2 49419900 E: mail@lindsaydynan.com.au

OJECT

MAITLAND CITY COUNCIL
ADMINISTRATION BUILDING

AAITI AND OITY OOLINGU

MAITLAND CITY COUNCIL

LEGEND

— 8.00 — EXISTING CONTOUR

EXISTING SPOTLEVEL

DESIGN SPOTLEVEL

NEW STORMWATER DRAINAGE PIT, INSTALLED TO MANUFACTURER'S SPECIFICATIONS

NEW PVC STORMWATER DRAINAGE PIPE LAID AT 1.0% MIN FALL (U.N.O.) IN ACCORDANCE WITH MANUFACTURER'S SPECIFICATIONS

Ø100 SUBSOIL DRAINAGE PIPE C/W FILTER SOCK, LAID AT 1.0% MIN FALL TO OUTLET

GRATED DRAIN 150 MIN. (WIDE) x 150 MIN. (DEEP).
1% MIN FALL TO OUTLET

NEW OPEN DRAINAGE SWALE, REFER TO PLAN
FOR FURTHER DETAILS

OVERLAND FLOW PATH

DIRECTION OF SURFACE FALL

NEW ASPHALT CARPARK PAVEMENT,

DETAILS TO BE PROVIDED AT CC STAGE

NEW CONCRETE FOOTPATH PAVEMENT,

DETAILS TO BE PROVIDED AT CC STAGE

NEW ASPHALT ROAD PAVEMENT,

DETAILS TO BE PROVIDED AT CC STAGE

NEW RETAINING WALL

EXISTING ELECTRICAL SERVICE

EXISTING GAS SERVICE

EXISTING SEWER SERVICE

EXISTING TELSTRA SERVICE

EXISTING WATER SERVICE

DOLIND A DV LINE

EXISTING FENCE

EXISTING TREE

 B
 26/03/19
 ISSUED FOR DA APPROVAL

 A
 21/03/19
 ISSUED FOR INFORMATION

 REV
 DATE
 DRAWING STATUS

14676

STORMWATER DRAINAGE PLAN SHEET 3

 DRAWING STATUS
 SHEET SIZE


 FOR APPROVAL
 A1

 DRAWN
 DESIGNED
 APPROVED
 SCALE

 A.Vizl
 A.Thompson
 B.Rodgers
 1:100

 PROJECT No.
 DRAWING No.
 REVISION

NOT FOR CONSTRUCTION

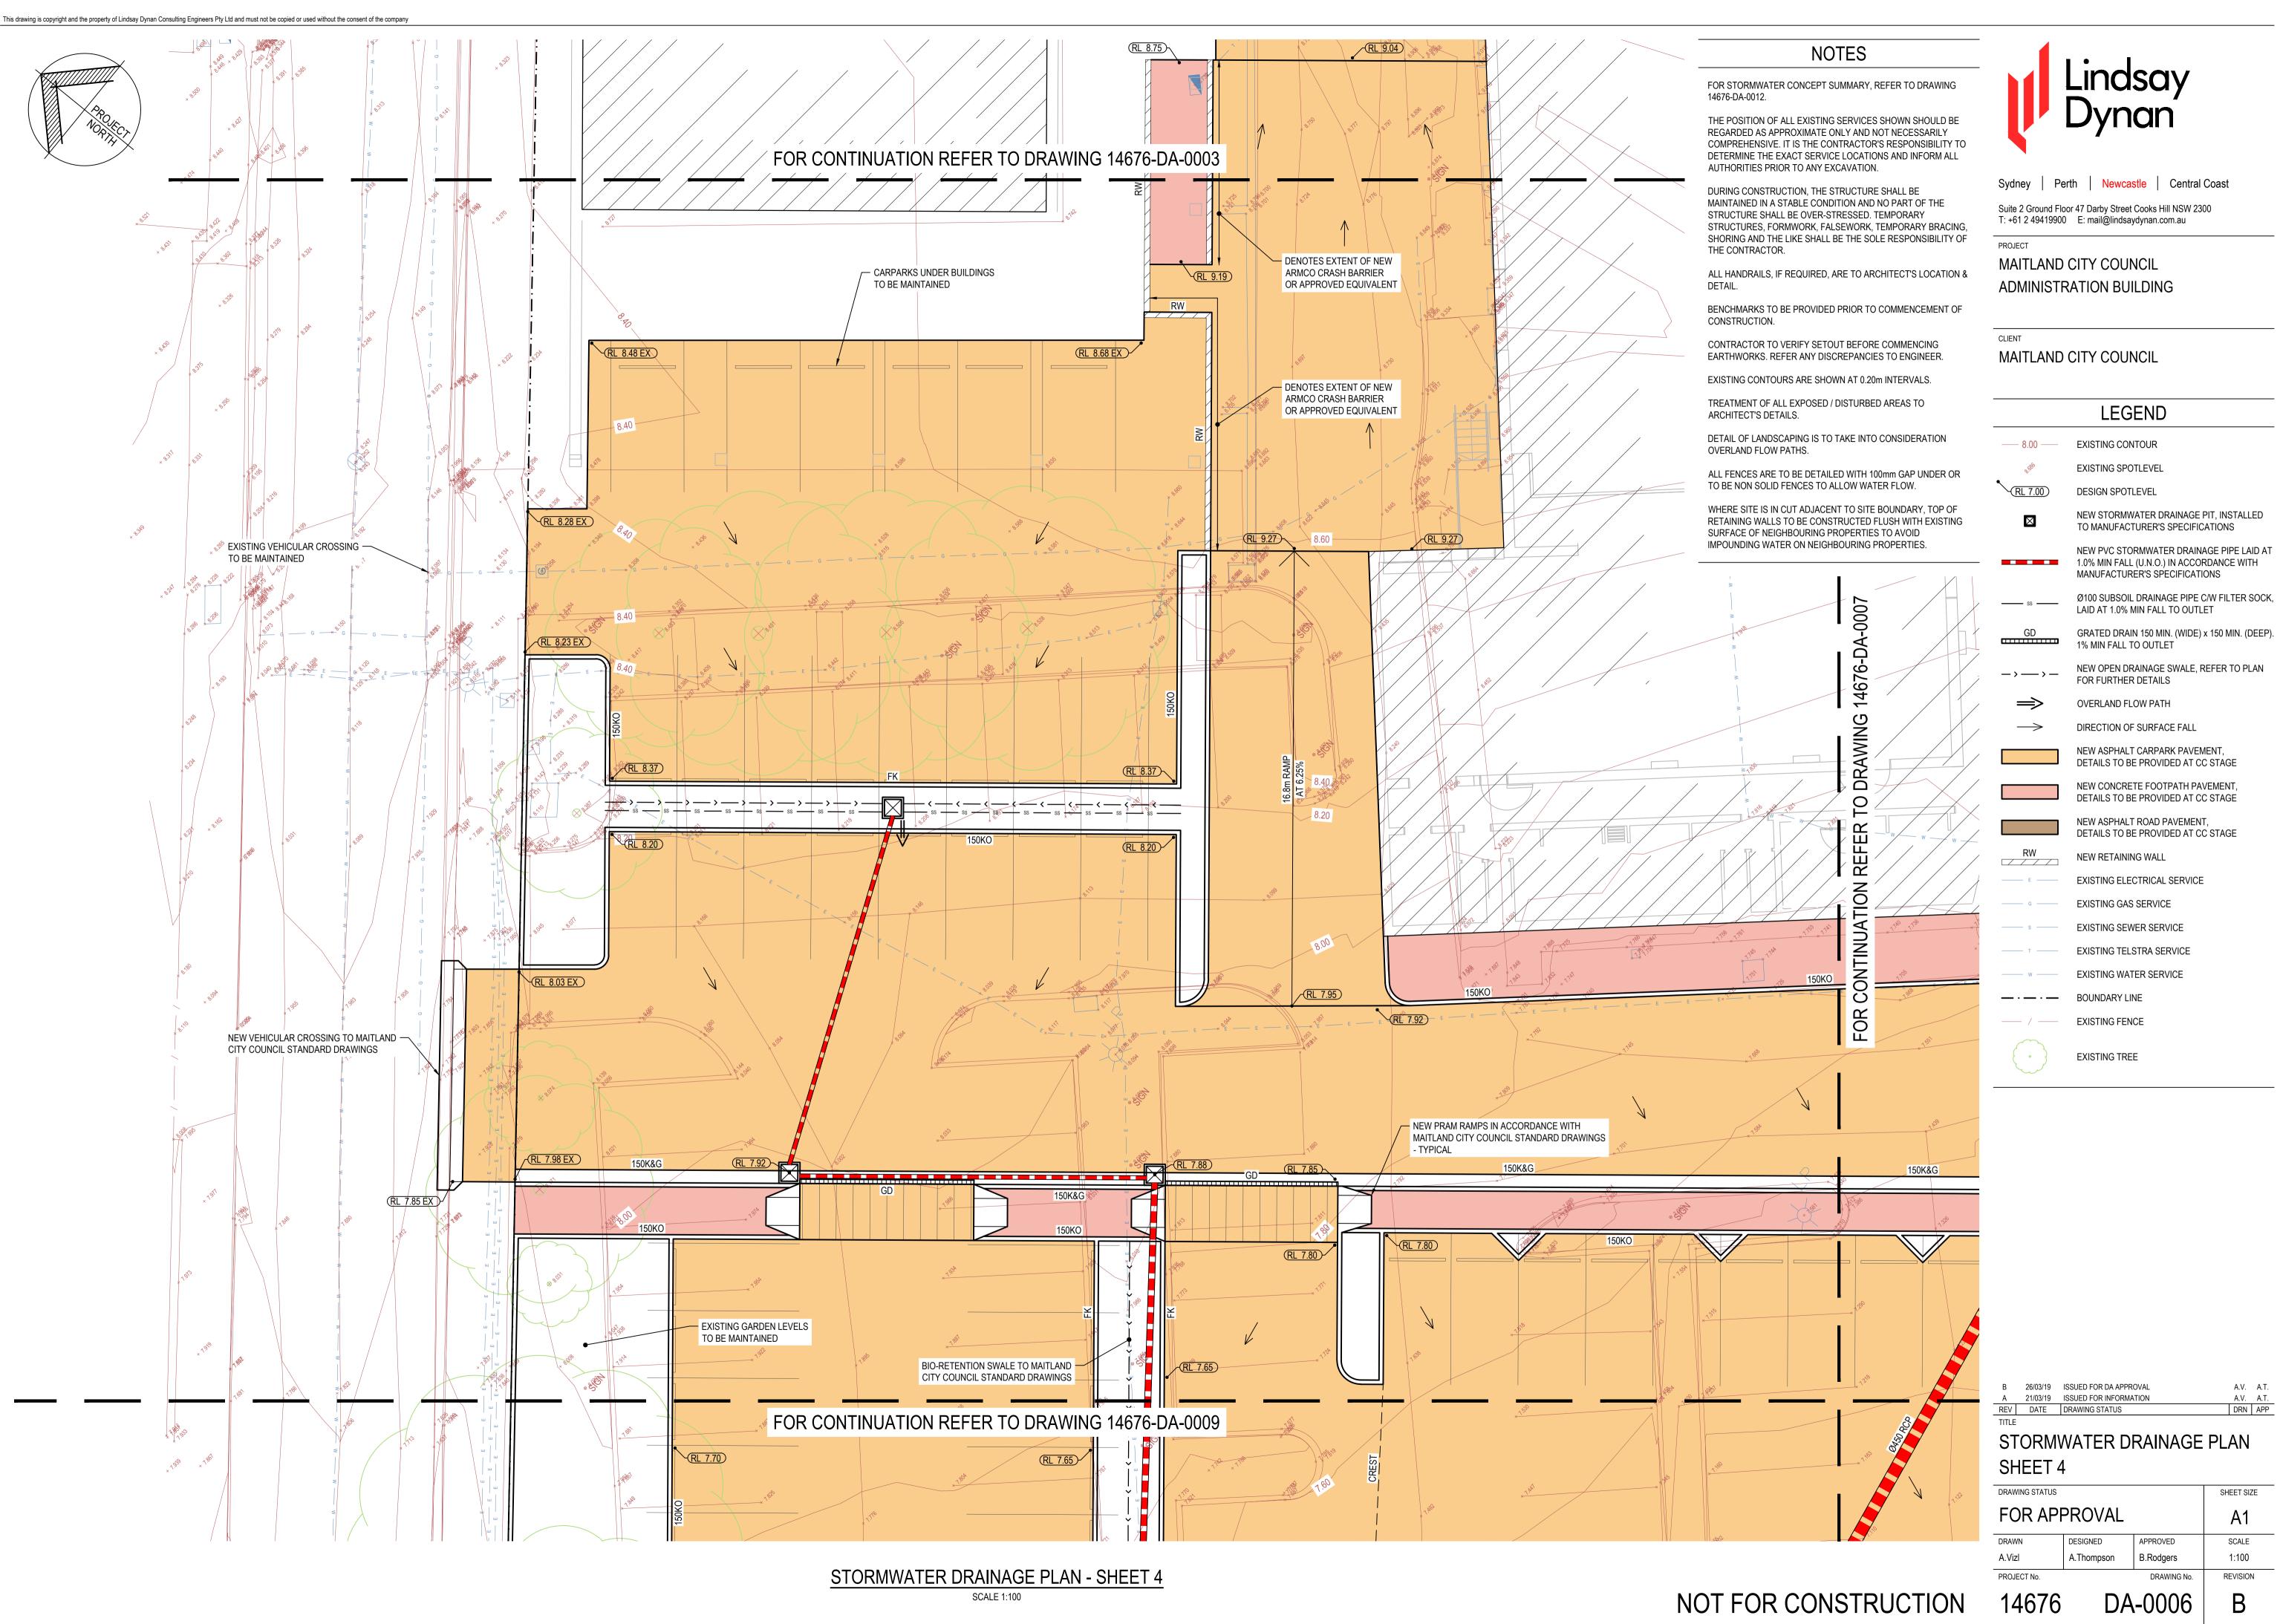

PLOTTED: 29/03/2019 4:17 PM


DRN APP

SHEET SIZE

**A**1

1:100

REVISION

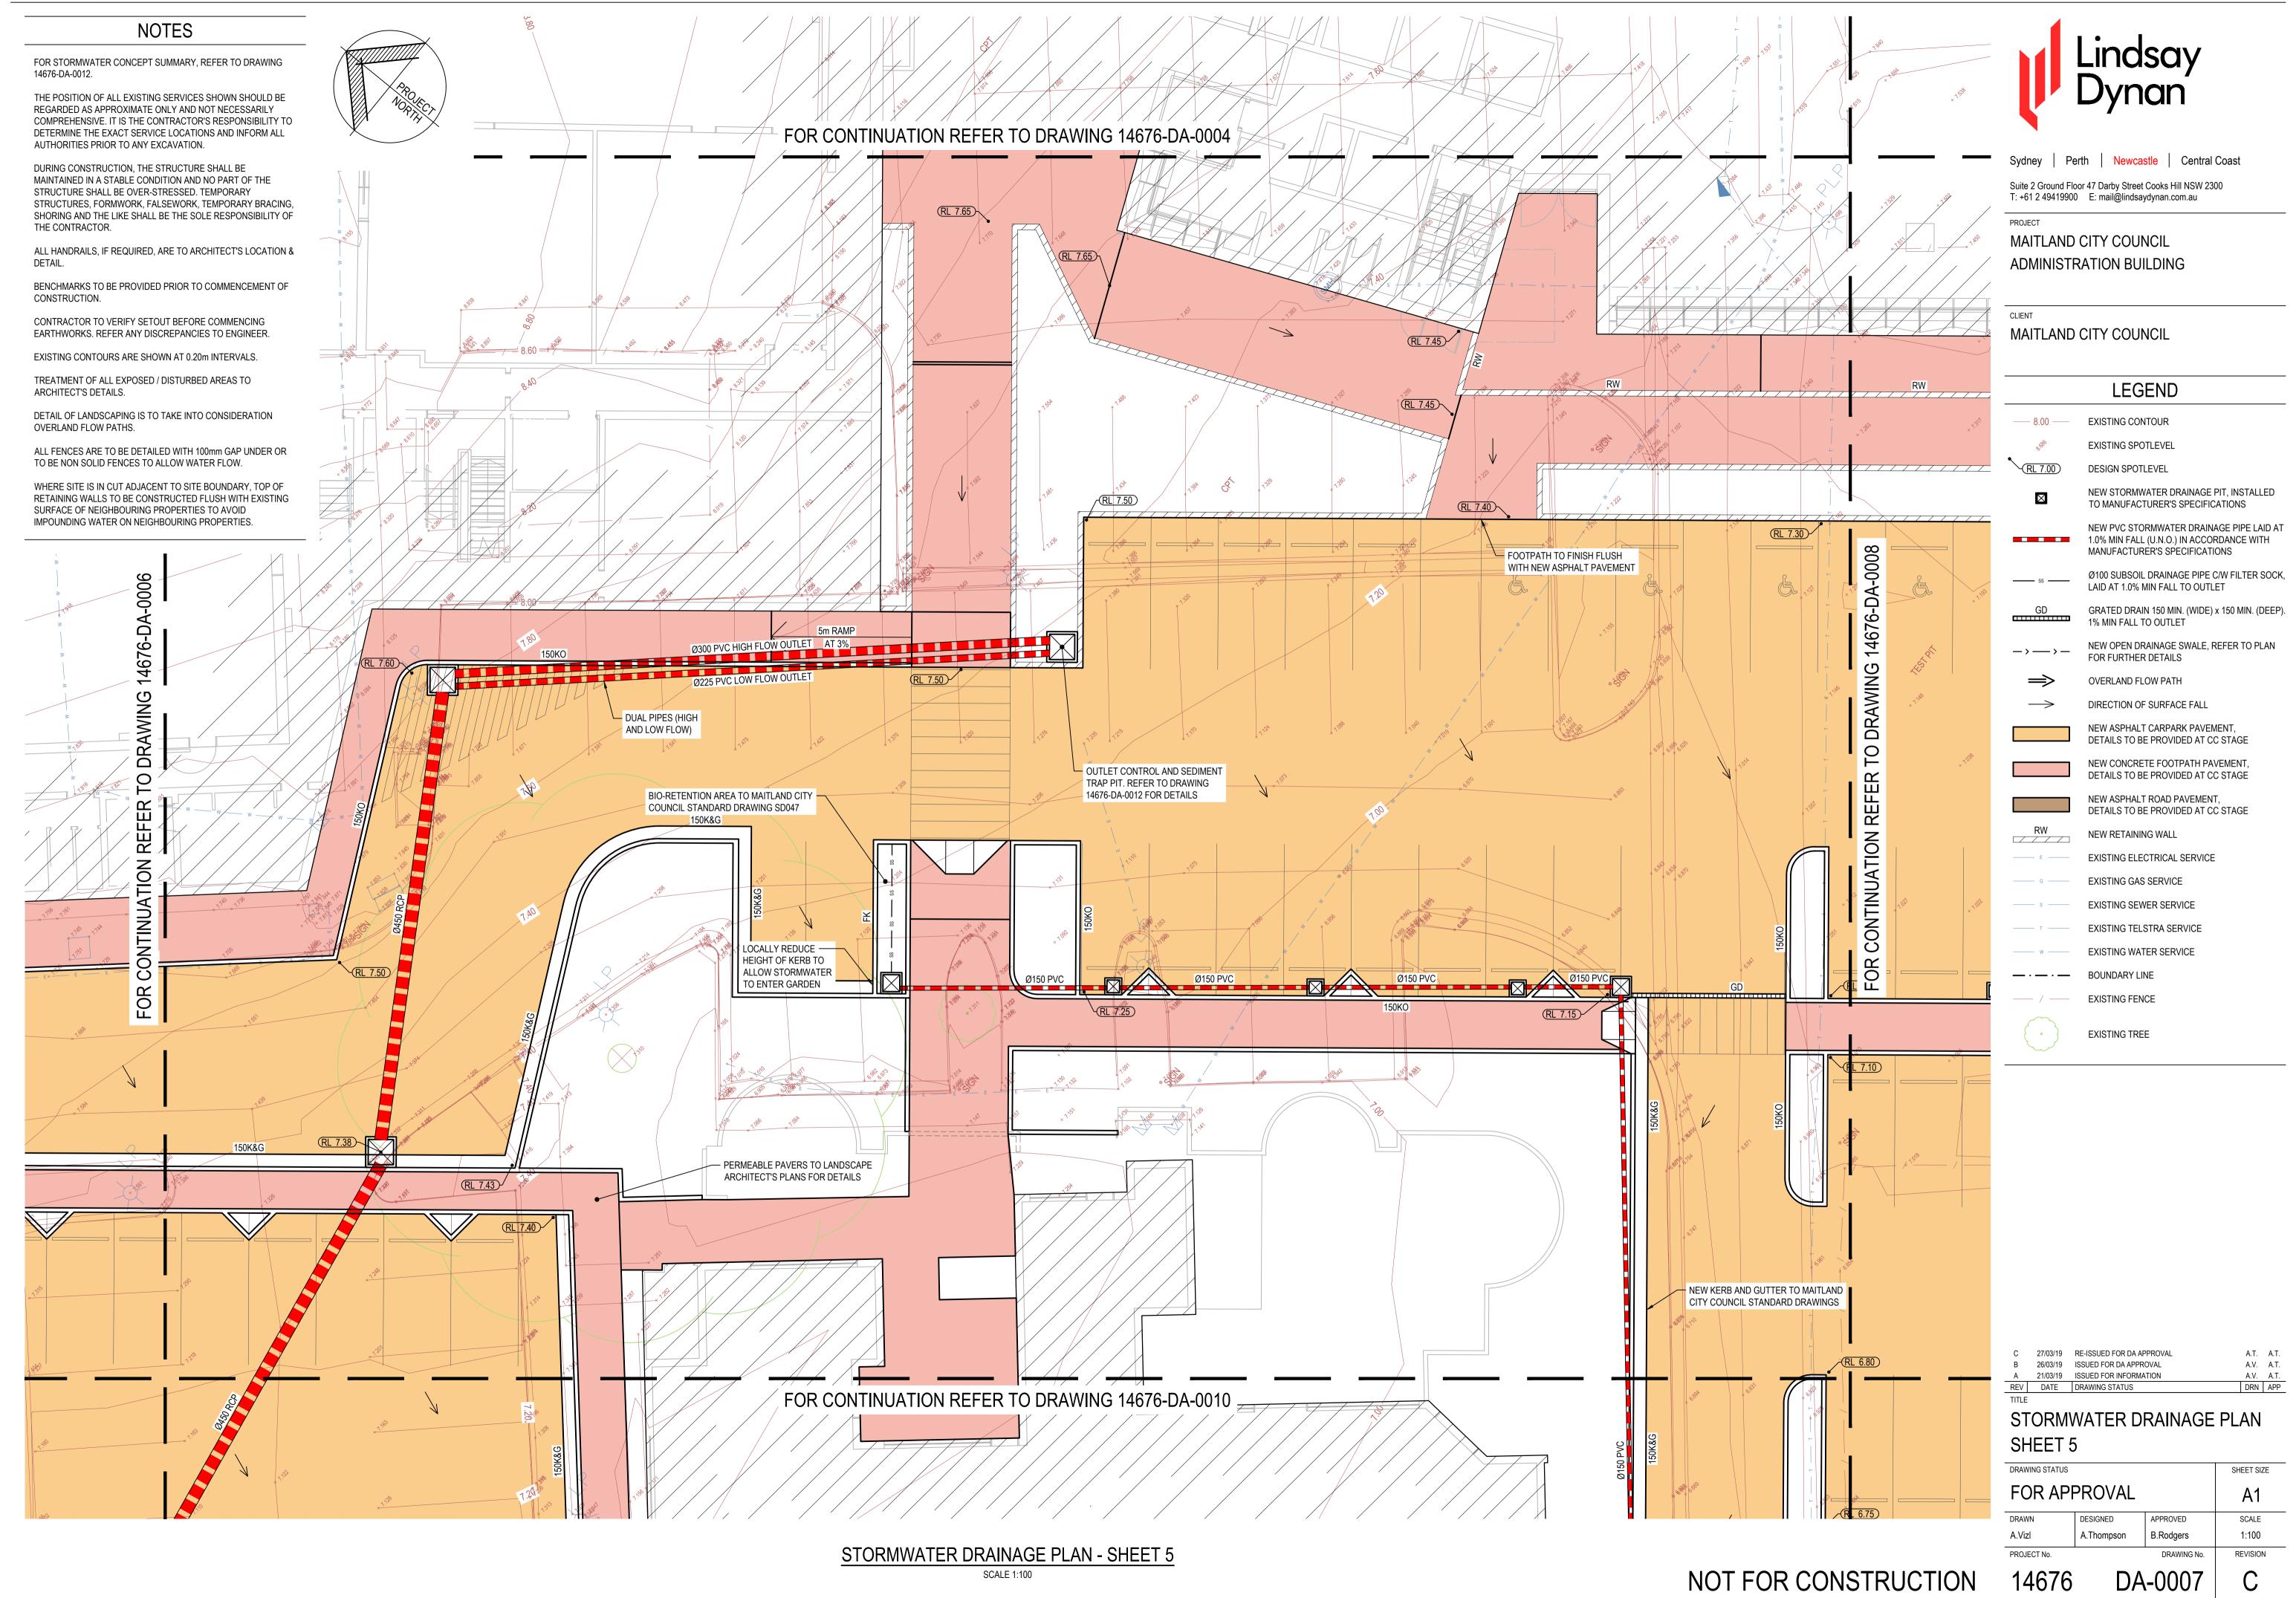

STORMWATER DRAINAGE PLAN - SHEET 6

SCALE 1:100

NOTES

FOR STORMWATER CONCEPT SUMMARY, REFER TO DRAWING 14676-DA-0012.

> THE POSITION OF ALL EXISTING SERVICES SHOWN SHOULD BE REGARDED AS APPROXIMATE ONLY AND NOT NECESSARILY COMPREHENSIVE. IT IS THE CONTRACTOR'S RESPONSIBILITY TO DETERMINE THE EXACT SERVICE LOCATIONS AND INFORM ALL AUTHORITIES PRIOR TO ANY EXCAVATION.

> DURING CONSTRUCTION, THE STRUCTURE SHALL BE MAINTAINED IN A STABLE CONDITION AND NO PART OF THE STRUCTURE SHALL BE OVER-STRESSED. TEMPORARY STRUCTURES, FORMWORK, FALSEWORK, TEMPORARY BRACING, SHORING AND THE LIKE SHALL BE THE SOLE RESPONSIBILITY OF THE CONTRACTOR.

> ALL HANDRAILS, IF REQUIRED, ARE TO ARCHITECT'S LOCATION &

BENCHMARKS TO BE PROVIDED PRIOR TO COMMENCEMENT OF CONSTRUCTION.

CONTRACTOR TO VERIFY SETOUT BEFORE COMMENCING EARTHWORKS. REFER ANY DISCREPANCIES TO ENGINEER.

EXISTING CONTOURS ARE SHOWN AT 0.20m INTERVALS.

TREATMENT OF ALL EXPOSED / DISTURBED AREAS TO

DETAIL OF LANDSCAPING IS TO TAKE INTO CONSIDERATION

ALL FENCES ARE TO BE DETAILED WITH 100mm GAP UNDER OR TO BE NON SOLID FENCES TO ALLOW WATER FLOW.

WHERE SITE IS IN CUT ADJACENT TO SITE BOUNDARY, TOP OF

RETAINING WALLS TO BE CONSTRUCTED FLUSH WITH EXISTING SURFACE OF NEIGHBOURING PROPERTIES TO AVOID IMPOUNDING WATER ON NEIGHBOURING PROPERTIES.



Sydney | Perth | Newcastle | Central Coast

Suite 2 Ground Floor 47 Darby Street Cooks Hill NSW 2300 T: +61 2 49419900 E: mail@lindsaydynan.com.au

MAITLAND CITY COUNCIL ADMINISTRATION BUILDING

MAITLAND CITY COUNCIL

LEGEND

EXISTING SPOTLEVEL

**DESIGN SPOTLEVEL** 

NEW STORMWATER DRAINAGE PIT, INSTALLED TO MANUFACTURER'S SPECIFICATIONS

NEW PVC STORMWATER DRAINAGE PIPE LAID AT

MANUFACTURER'S SPECIFICATIONS Ø100 SUBSOIL DRAINAGE PIPE C/W FILTER SOCK, LAID AT 1.0% MIN FALL TO OUTLET

1.0% MIN FALL (U.N.O.) IN ACCORDANCE WITH

GRATED DRAIN 150 MIN. (WIDE) x 150 MIN. (DEEP). 1% MIN FALL TO OUTLET

NEW OPEN DRAINAGE SWALE, REFER TO PLAN FOR FURTHER DETAILS

OVERLAND FLOW PATH DIRECTION OF SURFACE FALL

NEW ASPHALT CARPARK PAVEMENT, DETAILS TO BE PROVIDED AT CC STAGE

NEW CONCRETE FOOTPATH PAVEMENT, DETAILS TO BE PROVIDED AT CC STAGE

NEW ASPHALT ROAD PAVEMENT, DETAILS TO BE PROVIDED AT CC STAGE

**NEW RETAINING WALL** EXISTING ELECTRICAL SERVICE

EXISTING GAS SERVICE

**EXISTING SEWER SERVICE** 

**EXISTING TELSTRA SERVICE** 

**EXISTING WATER SERVICE** 

**EXISTING FENCE** 

**EXISTING TREE** 

B 26/03/19 ISSUED FOR DA APPROVAL 21/03/19 ISSUED FOR INFORMATION

14676

STORMWATER DRAINAGE PLAN SHEET 6

DRAWING STATUS SHEET SIZE FOR APPROVAL A.Vizl 1:100 B.Rodgers PROJECT No. REVISION

NOT FOR CONSTRUCTION

Α1 DRAWN SCALE A.Vizl A.Thompson 1:100 B.Rodgers PROJECT No. REVISION DRAWING No. 14676

SCALE 1:100

NOT FOR CONSTRUCTION

DO NOT SCALE - THIS DRAWING MAY BE A REDUCED COPY

CONSTRUCTION.

BENCHMARKS TO BE PROVIDED PRIOR TO COMMENCEMENT OF



Sydney | Perth | Newcastle | Central Coast

Suite 2 Ground Floor 47 Darby Street Cooks Hill NSW 2300 T: +61 2 49419900 E: mail@lindsaydynan.com.au

MAITLAND CITY COUNCIL ADMINISTRATION BUILDING

MAITLAND CITY COUNCIL

	LEGEND				
8.00	EXISTING CONTOUR				
\$15.8%	EXISTING SPOTLEVEL				
RL 7.00	DESIGN SPOTLEVEL				
×	NEW STORMWATER DRAINAGE PIT, INSTALLED TO MANUFACTURER'S SPECIFICATIONS				
	NEW PVC STORMWATER DRAINAGE PIPE LAID A 1.0% MIN FALL (U.N.O.) IN ACCORDANCE WITH MANUFACTURER'S SPECIFICATIONS				
ss	Ø100 SUBSOIL DRAINAGE PIPE C/W FILTER SOC LAID AT 1.0% MIN FALL TO OUTLET				
GD	GRATED DRAIN 150 MIN. (WIDE) x 150 MIN. (DEE 1% MIN FALL TO OUTLET				
->>-	NEW OPEN DRAINAGE SWALE, REFER TO PLAN FOR FURTHER DETAILS				
$\Longrightarrow$	OVERLAND FLOW PATH				
$\rightarrow$	DIRECTION OF SURFACE FALL				
	NEW ASPHALT CARPARK PAVEMENT, DETAILS TO BE PROVIDED AT CC STAGE				
	NEW CONCRETE FOOTPATH PAVEMENT, DETAILS TO BE PROVIDED AT CC STAGE				
	NEW ASPHALT ROAD PAVEMENT, DETAILS TO BE PROVIDED AT CC STAGE				
RW	NEW RETAINING WALL				
—— Е ——	EXISTING ELECTRICAL SERVICE				
G	EXISTING GAS SERVICE				
s	EXISTING SEWER SERVICE				
— т —	EXISTING TELSTRA SERVICE				
——— w ———	EXISTING WATER SERVICE				
<b>-</b> · <b>-</b> ·-	BOUNDARY LINE				
/	EXISTING FENCE				
	EXISTING TREE				

FOR STORMWATER CONCEPT SUMMARY, REFER TO DRAWING 14676-DA-0012.

THE POSITION OF ALL EXISTING SERVICES SHOWN SHOULD BE REGARDED AS APPROXIMATE ONLY AND NOT NECESSARILY COMPREHENSIVE. IT IS THE CONTRACTOR'S RESPONSIBILITY TO DETERMINE THE EXACT SERVICE LOCATIONS AND INFORM ALL AUTHORITIES PRIOR TO ANY EXCAVATION.

DURING CONSTRUCTION, THE STRUCTURE SHALL BE MAINTAINED IN A STABLE CONDITION AND NO PART OF THE STRUCTURE SHALL BE OVER-STRESSED. TEMPORARY STRUCTURES, FORMWORK, FALSEWORK, TEMPORARY BRACING, SHORING AND THE LIKE SHALL BE THE SOLE RESPONSIBILITY OF THE CONTRACTOR.

ALL HANDRAILS, IF REQUIRED, ARE TO ARCHITECT'S LOCATION &

BENCHMARKS TO BE PROVIDED PRIOR TO COMMENCEMENT OF CONSTRUCTION.

CONTRACTOR TO VERIFY SETOUT BEFORE COMMENCING EARTHWORKS. REFER ANY DISCREPANCIES TO ENGINEER.

EXISTING CONTOURS ARE SHOWN AT 0.20m INTERVALS.

TREATMENT OF ALL EXPOSED / DISTURBED AREAS TO ARCHITECT'S DETAILS.

DETAIL OF LANDSCAPING IS TO TAKE INTO CONSIDERATION OVERLAND FLOW PATHS.

ALL FENCES ARE TO BE DETAILED WITH 100mm GAP UNDER OR TO BE NON SOLID FENCES TO ALLOW WATER FLOW.

WHERE SITE IS IN CUT ADJACENT TO SITE BOUNDARY, TOP OF RETAINING WALLS TO BE CONSTRUCTED FLUSH WITH EXISTING

SURFACE OF NEIGHBOURING PROPERTIES TO AVOID IMPOUNDING WATER ON NEIGHBOURING PROPERTIES.

B 26/03/19 ISSUED FOR DA APPROVAL A.V. A.T. A 21/03/19 ISSUED FOR INFORMATION A.V. A.T. REV DATE DRAWING STATUS DRN APP

# STORMWATER DRAINAGE PLAN SHEET 9


DRAWING STATUS	SHEET SIZE		
FOR APP	A1		
DRAWN	DESIGNED	APPROVED	SCALE
A.Vizl	A.Thompson	B.Rodgers	1:100
PROJECT No.		DRAWING No.	REVISION
14676	DΑ	-0011	R

STORMWATER DRAINAGE PLAN - SHEET 9


SCALE 1:100


NOT FOR CONSTRUCTION


PLOTTED: 29/03/2019 4:27 PM

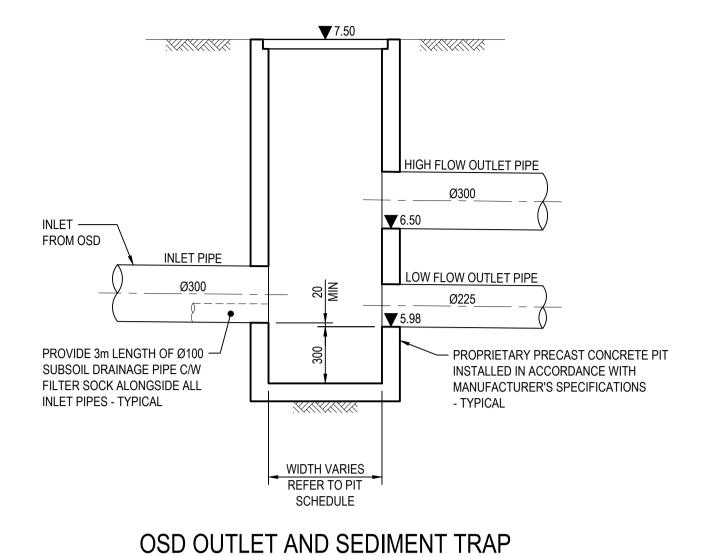

SCALE 1:20

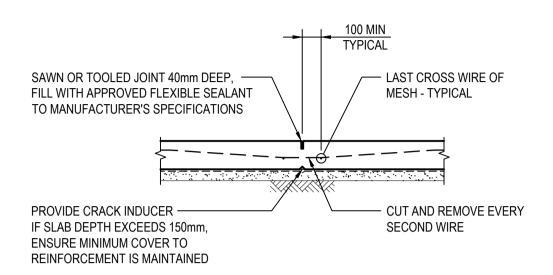

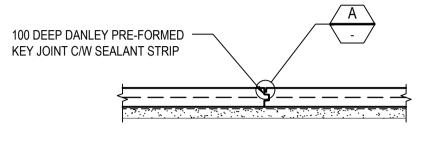

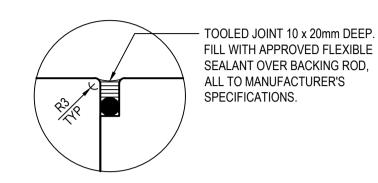




TIED SAWN JOINT - TSJ SCALE 1:20


**KEY JOINT - KJ** SCALE 1:20



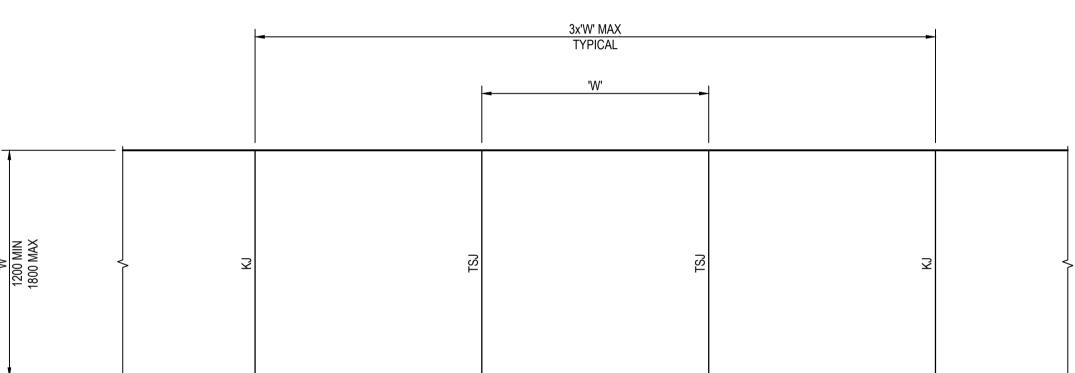


AND JOINTING PLAN
SCALE 1:20


TYPICAL CONCRETE FOOTPATH SETOUT

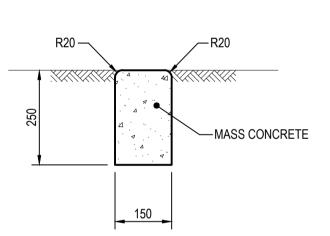


FLUSH KERB - FK

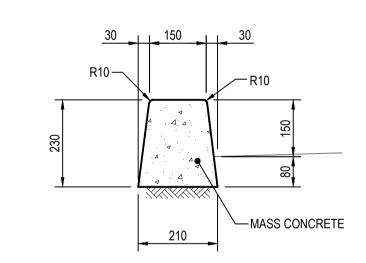


KERB ONLY - 150KO

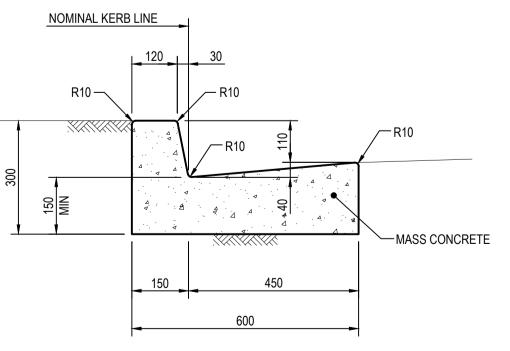



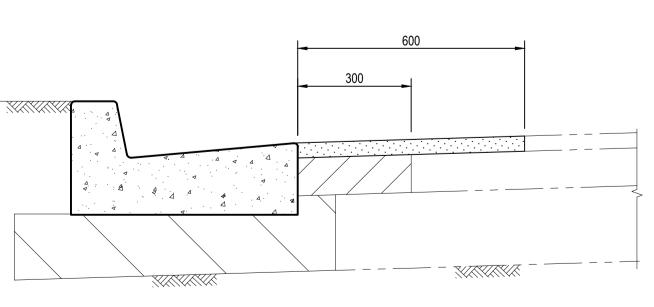

TYPICAL KERB REPLACEMENT DETAIL SCALE 1:10

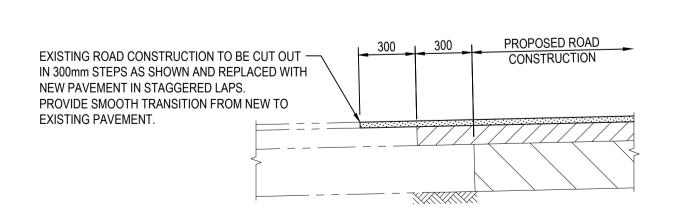

#### NEW TO EXISTING PAVEMENT ABUTMENT DETAIL SCALE 1:20

STORMWATER DRAINAGE **DETAILS** DRAWING STATUS SHEET SIZE FOR APPROVAL Α1 SCALE A.Vizl A.Thompson B.Rodgers 1:20, 1:10, 1:2

A 26/03/19 ISSUED FOR DA APPROVAL

REV DATE DRAWING STATUS

Sydney | Perth | Newcastle | Central Coast

**CONCEPT SUMMARY** 

THE PROPOSED DEVELOPMENT IS LOCATED AT 263-283 HIGH

STREET MAITLAND AND WILL CONSIST OF THE CONSTRUCTION

ALL RUNOFF FROM NEW ROOF AREAS WILL BE DIRECTED TO A BELOW GROUND OSD SYSTEM VIA CHARGED DOWNPIPES.

DISCHARGE TO PRE DEVELOPMENT DISCHARGE FOR ALL STORM EVENTS UP TO AND INCLUDING THE 1% AEP EVENT AND WILL OUTLET VIA A HIGH AND LOW FLOW SYSTEM TO THE NEW PIT

MINOR FLOWS GENERATED ACROSS THE CARPARK UP TO AND INCLUDING THE 10% AEP WILL BE DIRECTED TO A SERIES OF BIORETENTION BASINS AND SWALES WHERE POSSIBLE AND

PROPOSED STORMWATER NETWORK ON GRANT STREET VIA A

FOR ALL STORMWATER CALCULATIONS PLEASE REFER TO THE

THE NEW OSD SYSTEM HAS BEEN DESIGNED LIMIT PEAK

AND PIPE NETWORK PROVIDED IN THE CARPARK.

CAPTURED BY A NETWORK OF PITS AND PIPES.

SUBSURFACE PIPE.

ATTACHED DRAINS MODEL.

THE PIT AND PIPE NETWORK WILL DISCHARGE TO THE

OF THE NEW CITY ADMINISTRATION CENTRE ALONG WITH A NEW

Suite 2 Ground Floor 47 Darby Street Cooks Hill NSW 2300 T: +61 2 49419900 E: mail@lindsaydynan.com.au

MAITLAND CITY COUNCIL

MAITLAND CITY COUNCIL

CARPARK AND ASSOCIATED LANDSCAPING.

ADMINISTRATION BUILDING

PROJECT

CLIENT

NOT FOR CONSTRUCTION


PROJECT No. DRAWING No.


14676

DO NOT SCALE - THIS DRAWING MAY BE A REDUCED COPY

REVISION

DRN APP

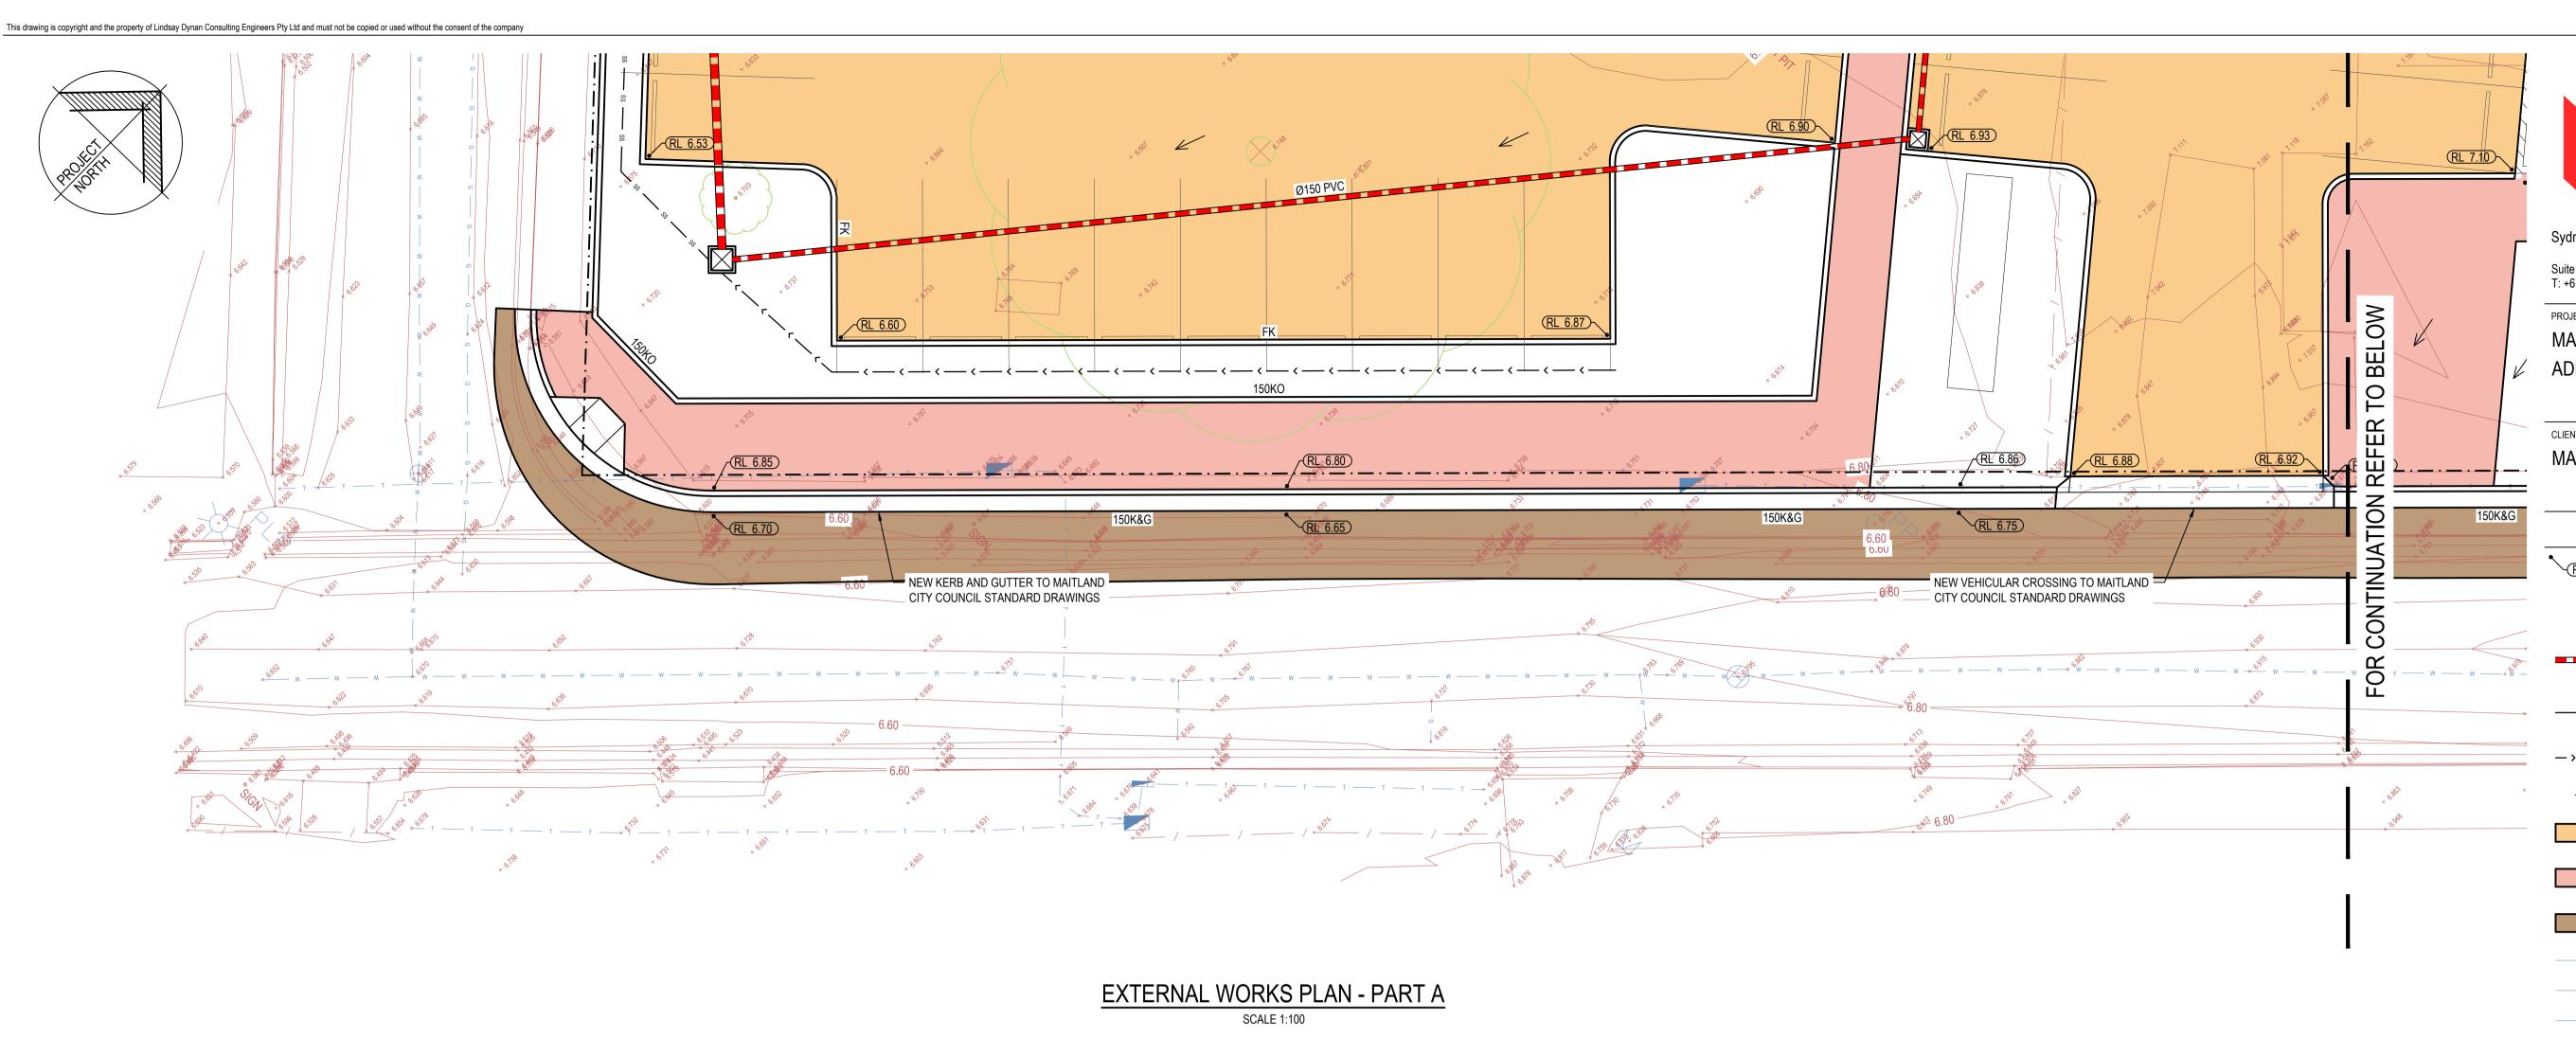

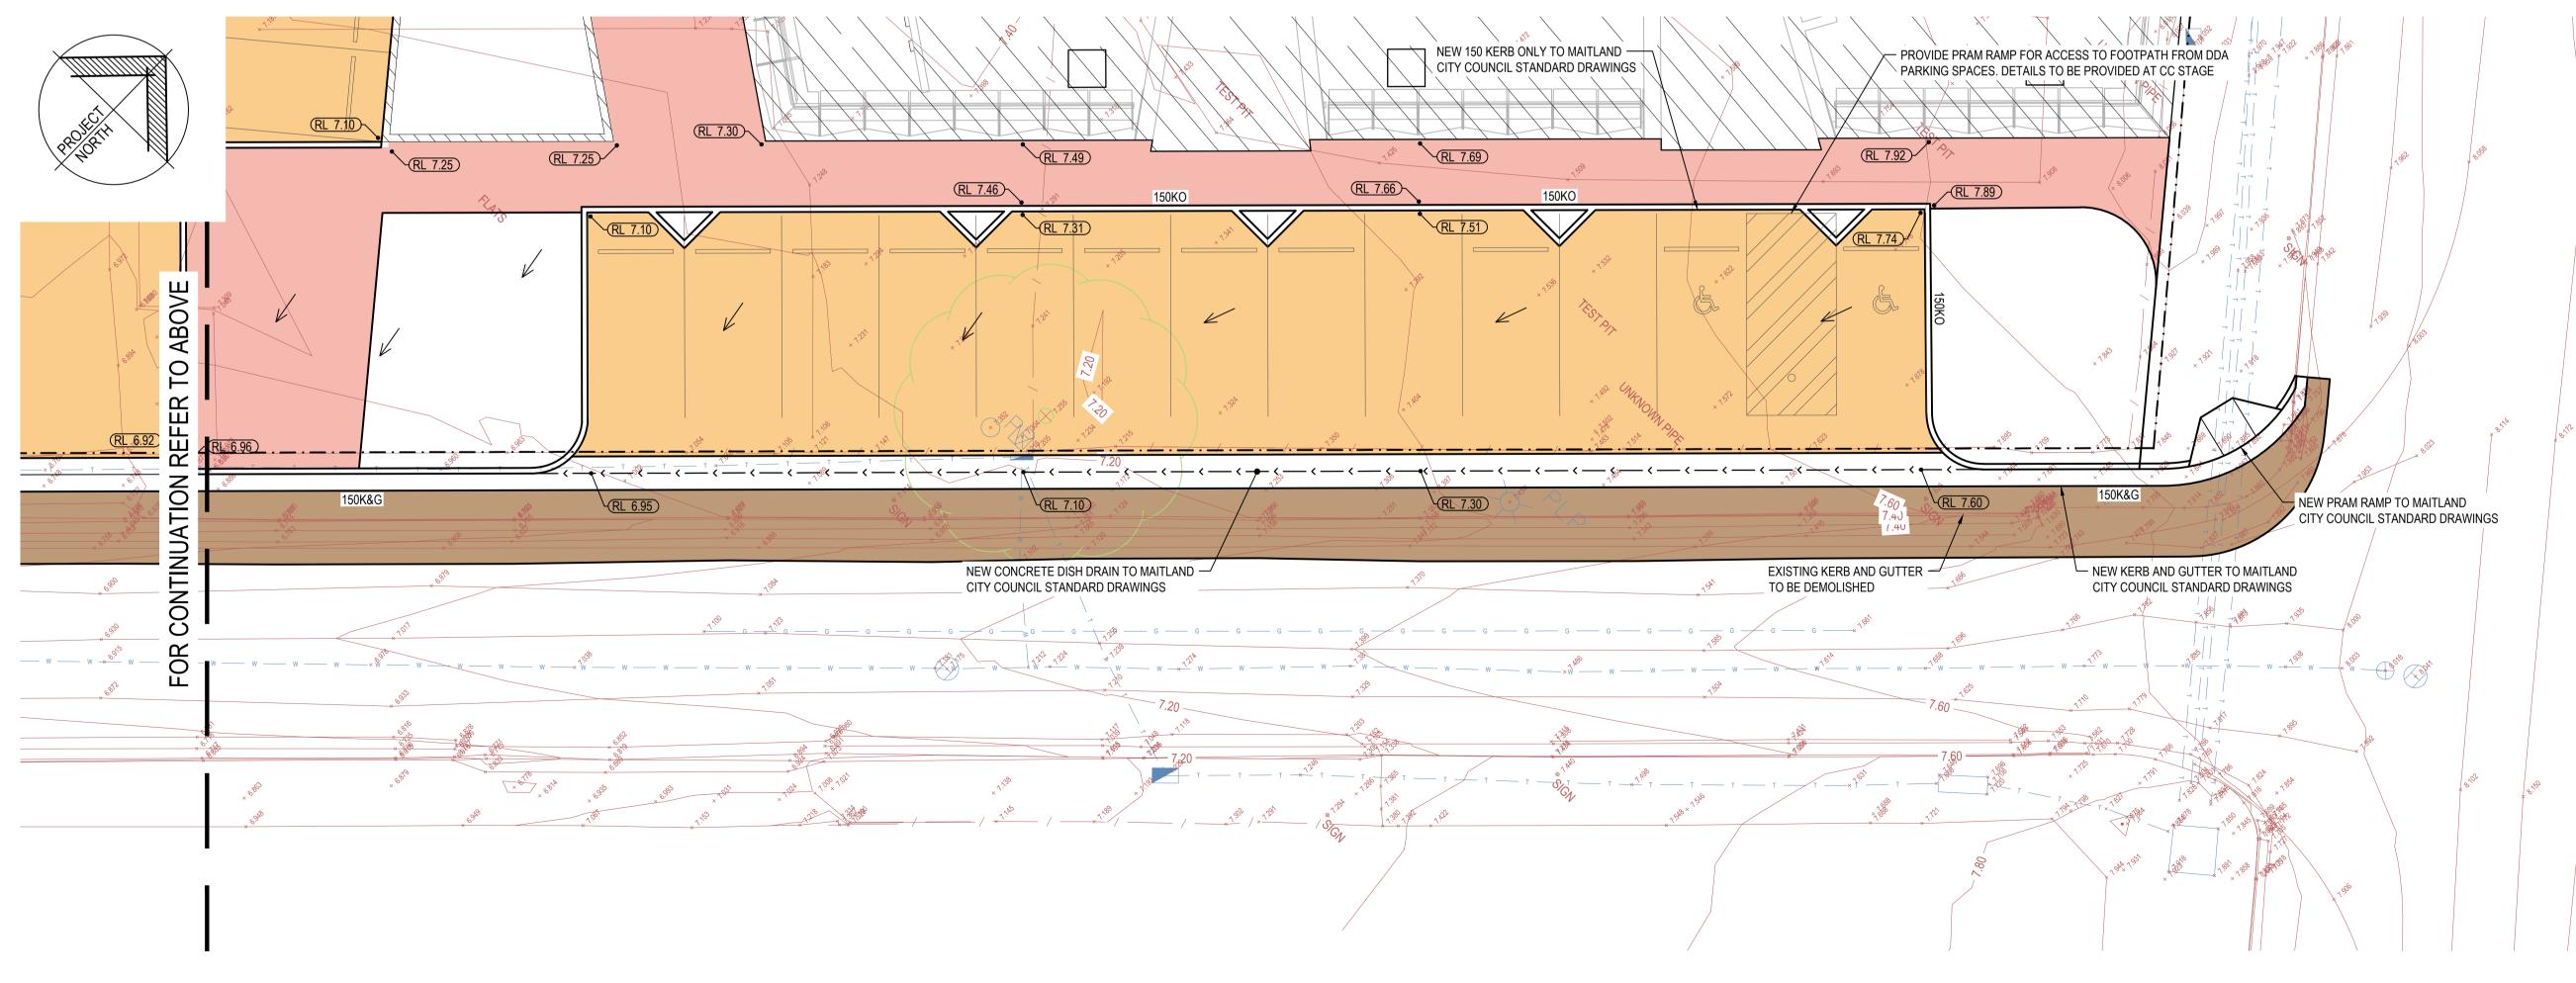



Sydney | Perth | Newcastle | Central Coast

Suite 2 Ground Floor 47 Darby Street Cooks Hill NSW 2300 T: +61 2 49419900 E: mail@lindsaydynan.com.au

MAITLAND CITY COUNCIL ADMINISTRATION BUILDING

MAITLAND CITY COUNCIL

LEGEND

**DESIGN SPOTLEVEL** 

NEW STORMWATER DRAINAGE PIT, INSTALLED TO MANUFACTURER'S SPECIFICATIONS

1.0% MIN FALL (U.N.O.) IN ACCORDANCE WITH MANUFACTURER'S SPECIFICATIONS

NEW PVC STORMWATER DRAINAGE PIPE LAID AT

Ø100 SUBSOIL DRAINAGE PIPE C/W FILTER SOCK, LAID AT 1.0% MIN FALL TO OUTLET NEW OPEN DRAINAGE SWALE, REFER TO PLAN FOR FURTHER DETAILS

DIRECTION OF SURFACE FALL

NEW ASPHALT CARPARK PAVEMENT,

DETAILS TO BE PROVIDED AT CC STAGE NEW FOOTPATH PAVEMENT,

DETAILS TO BE PROVIDED AT CC STAGE NEW ASPHALT ROAD PAVEMENT,

DETAILS TO BE PROVIDED AT CC STAGE EXISTING GAS SERVICE

EXISTING TELSTRA SERVICE

EXISTING WATER SERVICE

**BOUNDARY LINE** 

**EXISTING FENCE** 

EXISTING TREE

NOTES

THE POSITION OF ALL EXISTING SERVICES SHOWN SHOULD BE REGARDED AS APPROXIMATE ONLY AND NOT NECESSARILY COMPREHENSIVE. IT IS THE CONTRACTOR'S RESPONSIBILITY TO DETERMINE THE EXACT SERVICE LOCATIONS AND INFORM ALL AUTHORITIES PRIOR TO ANY EXCAVATION.

DURING CONSTRUCTION, THE STRUCTURE SHALL BE MAINTAINED IN A STABLE CONDITION AND NO PART OF THE STRUCTURE SHALL BE OVER-STRESSED. TEMPORARY STRUCTURES, FORMWORK, FALSEWORK, TEMPORARY BRACING, SHORING AND THE LIKE SHALL BE THE SOLE RESPONSIBILITY OF THE CONTRACTOR.

ALL HANDRAILS, IF REQUIRED, ARE TO ARCHITECT'S LOCATION &

BENCHMARKS TO BE PROVIDED PRIOR TO COMMENCEMENT OF CONSTRUCTION. CONTRACTOR TO VERIFY SETOUT BEFORE COMMENCING

EARTHWORKS. REFER ANY DISCREPANCIES TO ENGINEER. EXISTING CONTOURS ARE SHOWN AT 0.20m INTERVALS.

TREATMENT OF ALL EXPOSED / DISTURBED AREAS TO ARCHITECT'S DETAILS. DETAIL OF LANDSCAPING IS TO TAKE INTO CONSIDERATION

OVERLAND FLOW PATHS. ALL FENCES ARE TO BE DETAILED WITH 100mm GAP UNDER OR

TO BE NON SOLID FENCES TO ALLOW WATER FLOW. WHERE SITE IS IN CUT ADJACENT TO SITE BOUNDARY, TOP OF

RETAINING WALLS TO BE CONSTRUCTED FLUSH WITH EXISTING SURFACE OF NEIGHBOURING PROPERTIES TO AVOID IMPOUNDING WATER ON NEIGHBOURING PROPERTIES.

A 26/03/19 ISSUED FOR DA APPROVAL REV DATE DRAWING STATUS

EXTERNAL WORKS PLAN

1.65 1.65 1.55 1.55 1.55 1.55 1.55 1.55	DRAWING STATUS	SHEET SIZE
	FOR APPROVAL	A1
	DRAWN DESIGNED APPROVED	SCALE
	A.Vizl A.Thompson B.Rodgers	1:100
	PROJECT No. DRAWING No.	REVISION
NOT FOR CONSTRUCTION	I 14676 DA-0020	Α